Site Prep CCTV Security Camera System

#568-12-103

FT. MEADE, SOUTH DAKOTA



<u>ARCHITECTURAL</u> FOURFRONT DESIGN INC. PH: (605) 342-9470 FAX: (605) 348-0571



MECHANICAL ENGINEERING WEST PLAINS ENGINEERING PH: (605) 348-7455 FAX: (605) 348-9445



ELECTRICAL ENGINEERING WEST PLAINS ENGINEERING PH: (605) 348-7455 FAX: (605) 348-9445

Office of

Construction

PROJECT INDEX:

GENERAL

Cover Sheet and Index

ARCHITECTURAL

Demolition, Floor and Ceiling Plans and Interior Elevations— Building 148 Buildings 120, 85, 72E and 44 Work A1.01

<u>Mechanical</u>


M1.00 Mechanical Plans M1.01 Mechanical Details and Symbols

Electrical


one eighth inch = one foot


0 4 8 16


Police/Security Electrical Plans E2.00 Overall CCTV/Security Plan — Sheet Index E3.00 CCTV/Security Plan - Building 113 South CCTV/Security Plan — Building 113 North E4.00 CCTV/Security Plan — Building 146 West and Building 145 South E5.00 CCTV/Security Plan — Building 146 East E6.00 E7.00 CCTV/Security Plan — Building 145 North CCTV/Security Plan - Building 148 Southwest CCTV/Security Plan — Building 148 Southeast E9.00 E10.00 CCTV/Security Plan - Building 148 Central E11.00 CCTV/Security Plan - Buildings 72, 85, 120 & 144 E12.00 Electrical Symbols/Abbreviations/Schedules

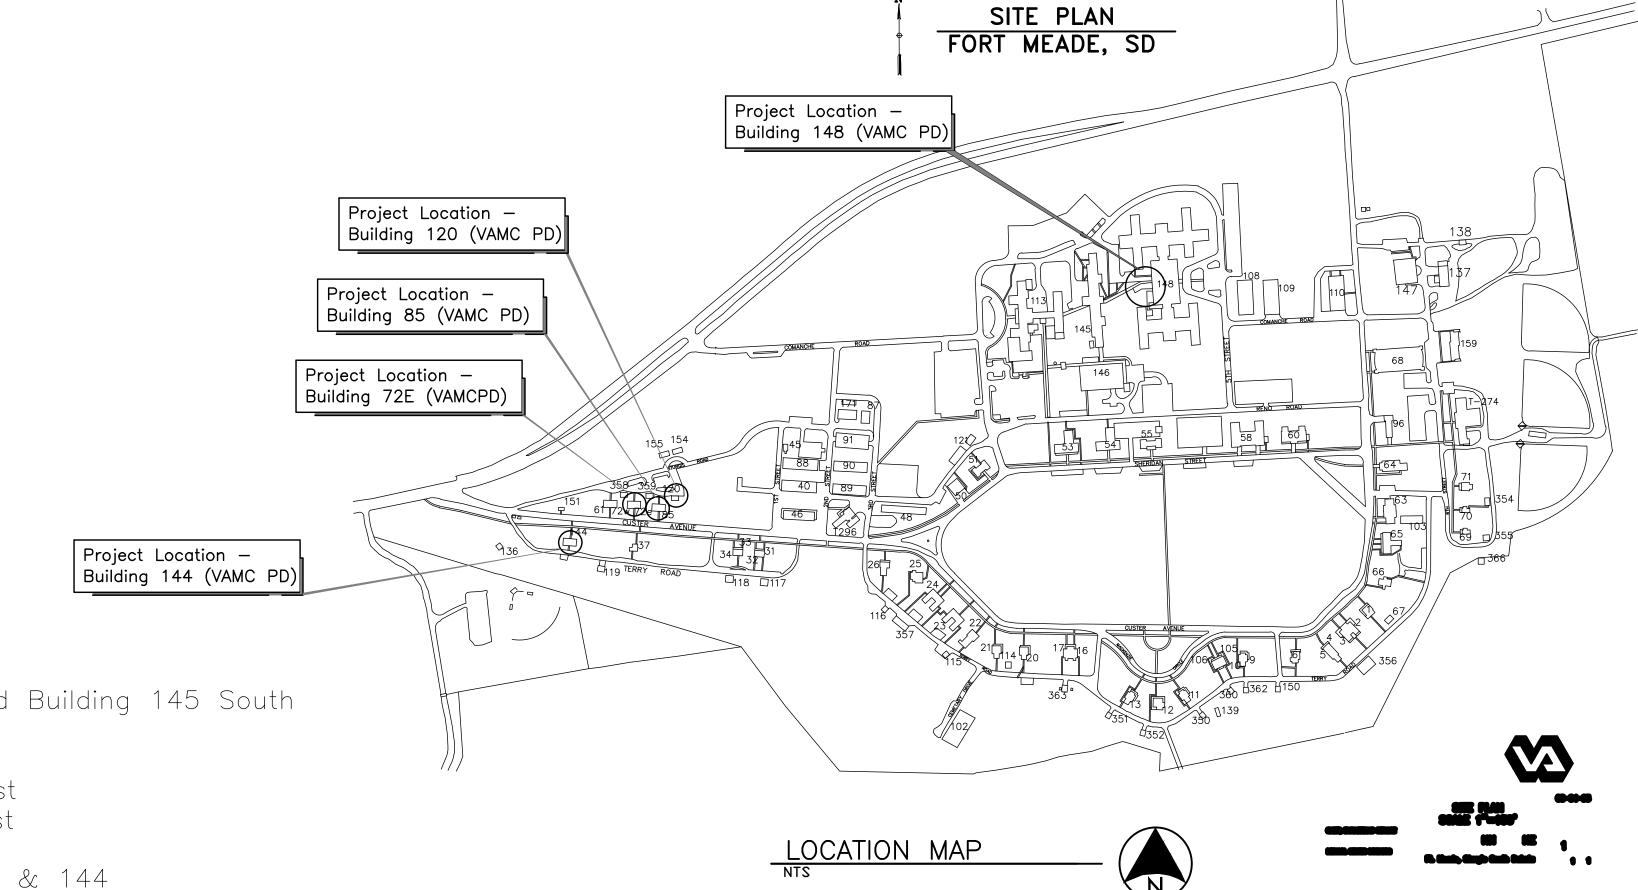

Project Number ARCHITECT/ENGINEERS: CONSULTANTS: CCTV Security Camera System Demolition, Floor and Ceiling Plans 568-12-103 and Interior Elevations Building Numbers 517 Seventh Street 148, 120, 85, 72E, 144 and Facilities Rapid City, SD 57701 Approved: Project Director Drawing Number Management (605) 342-9470 Ft. Meade, South Dakota (605) 348-0571 (fax) FOURFRONT DESIGN IN C Department of Veterans Affairs 10.1749.008

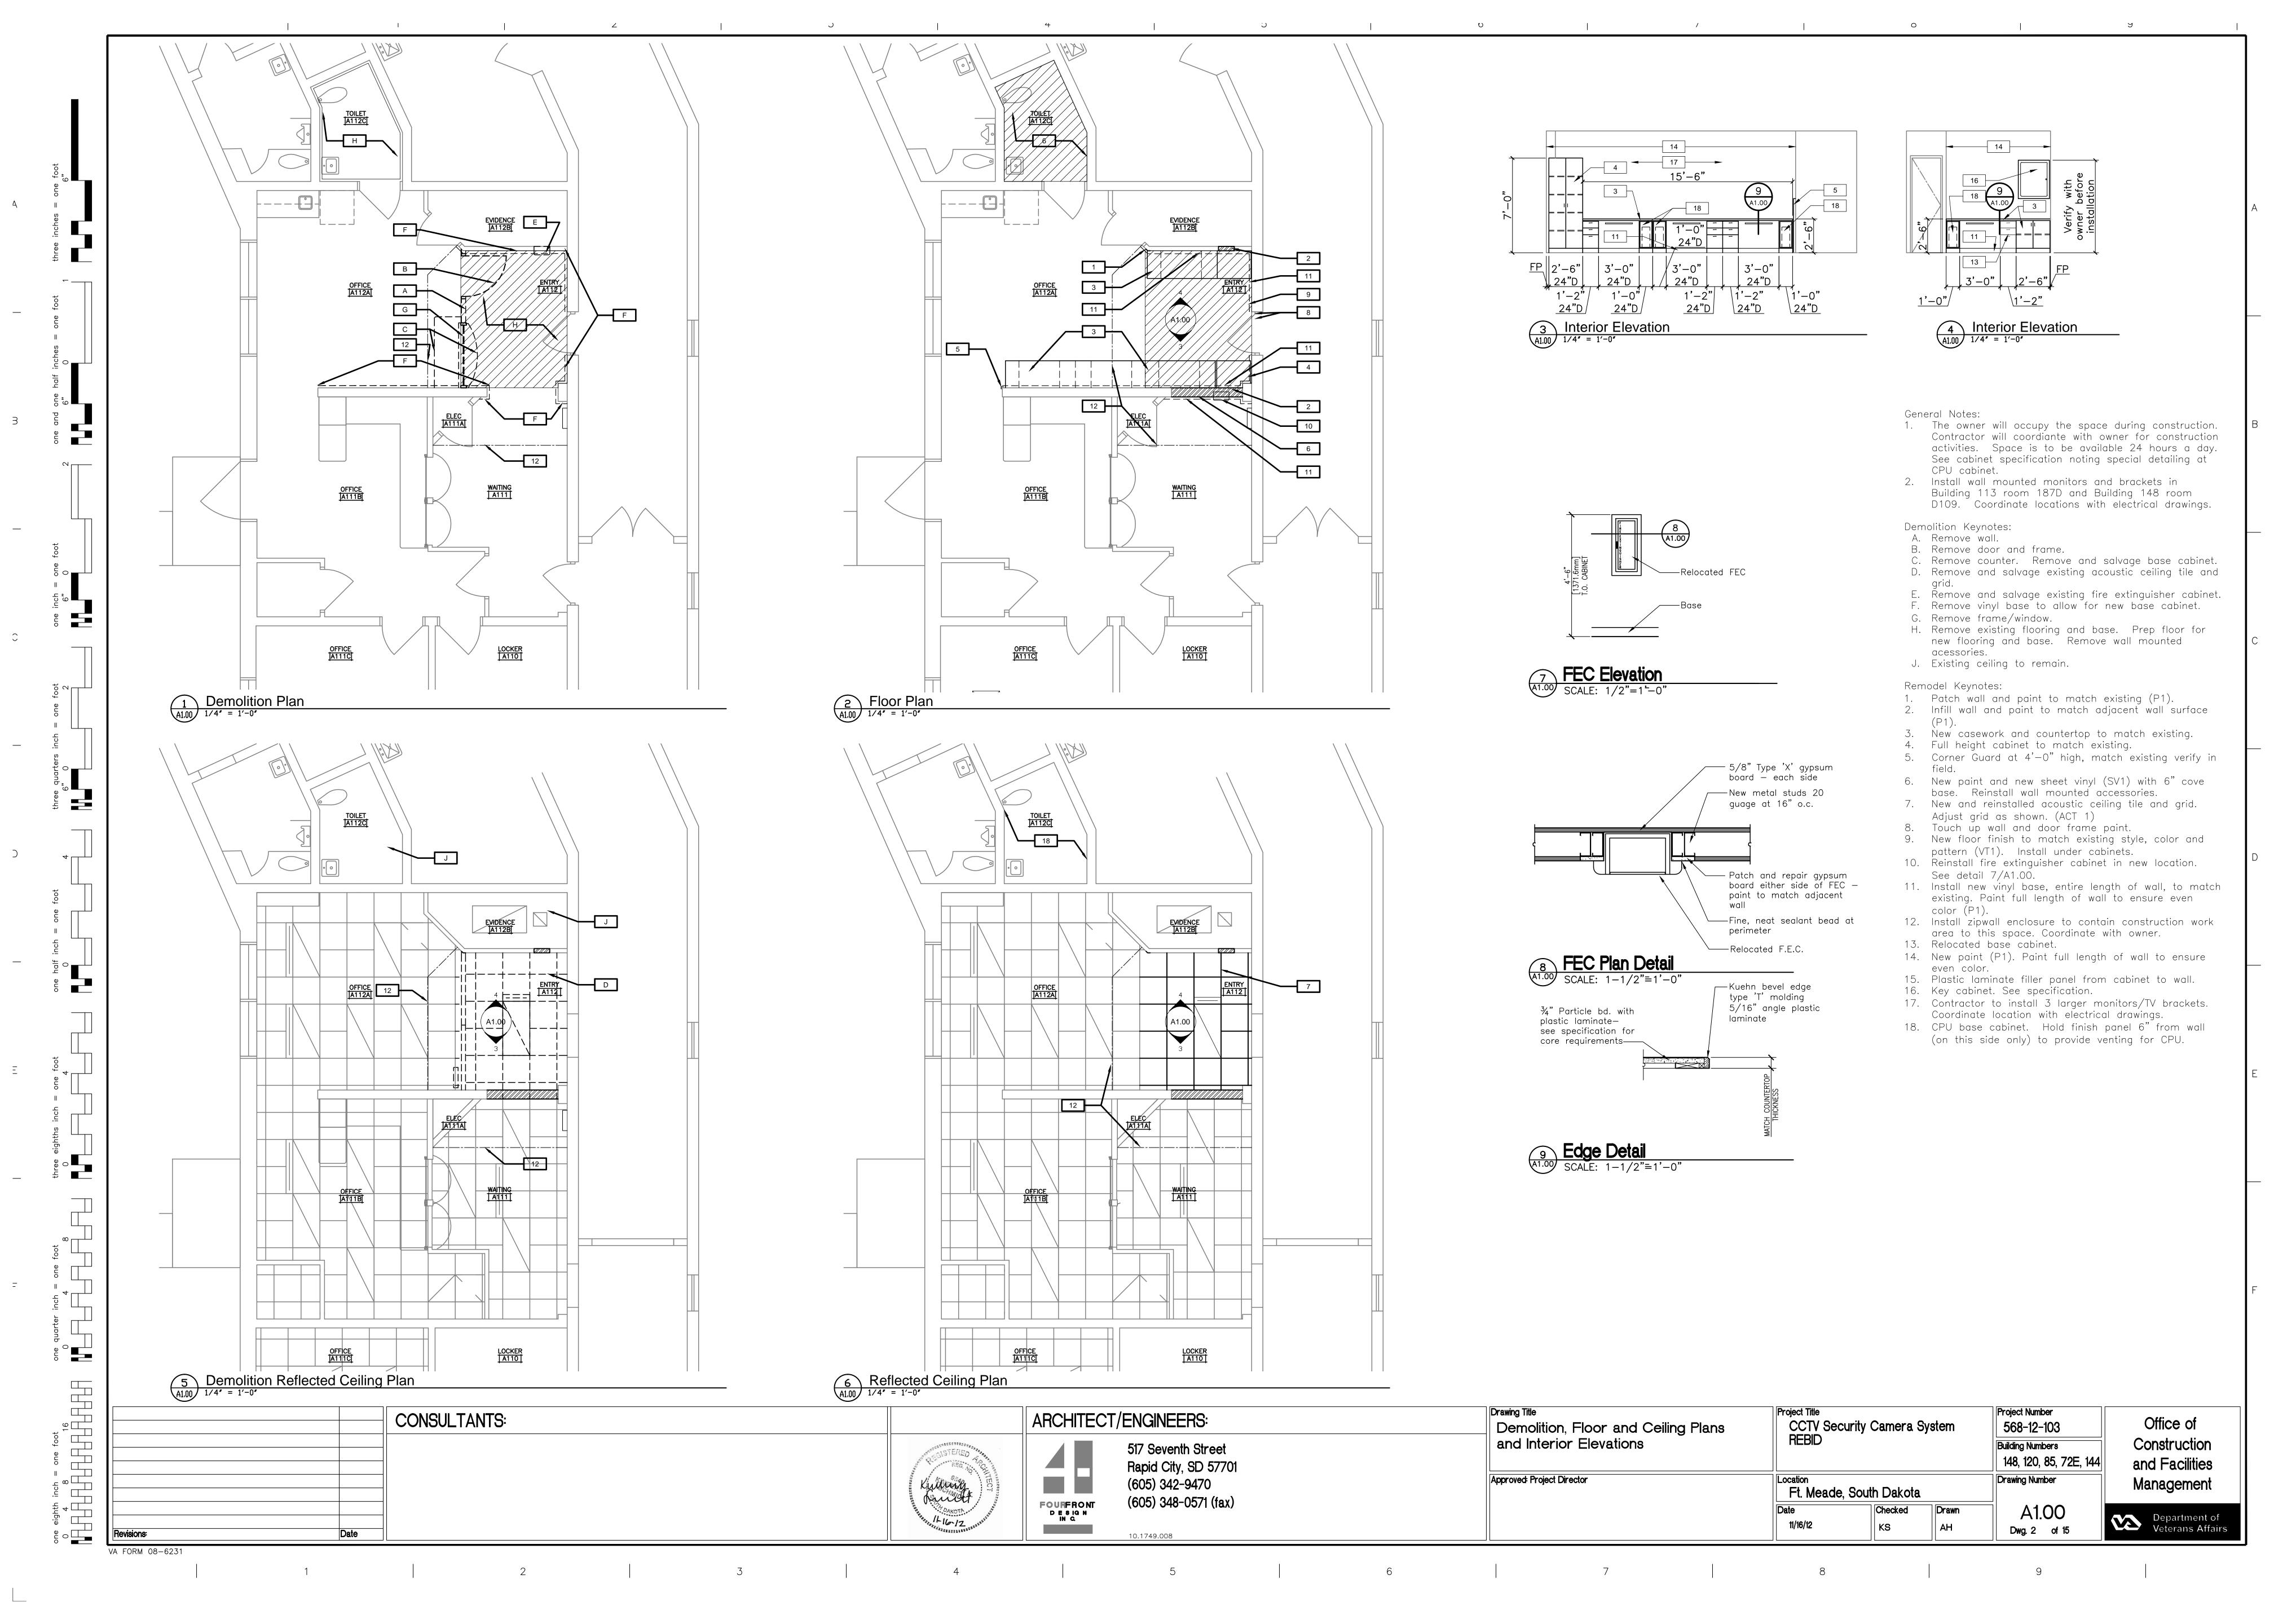


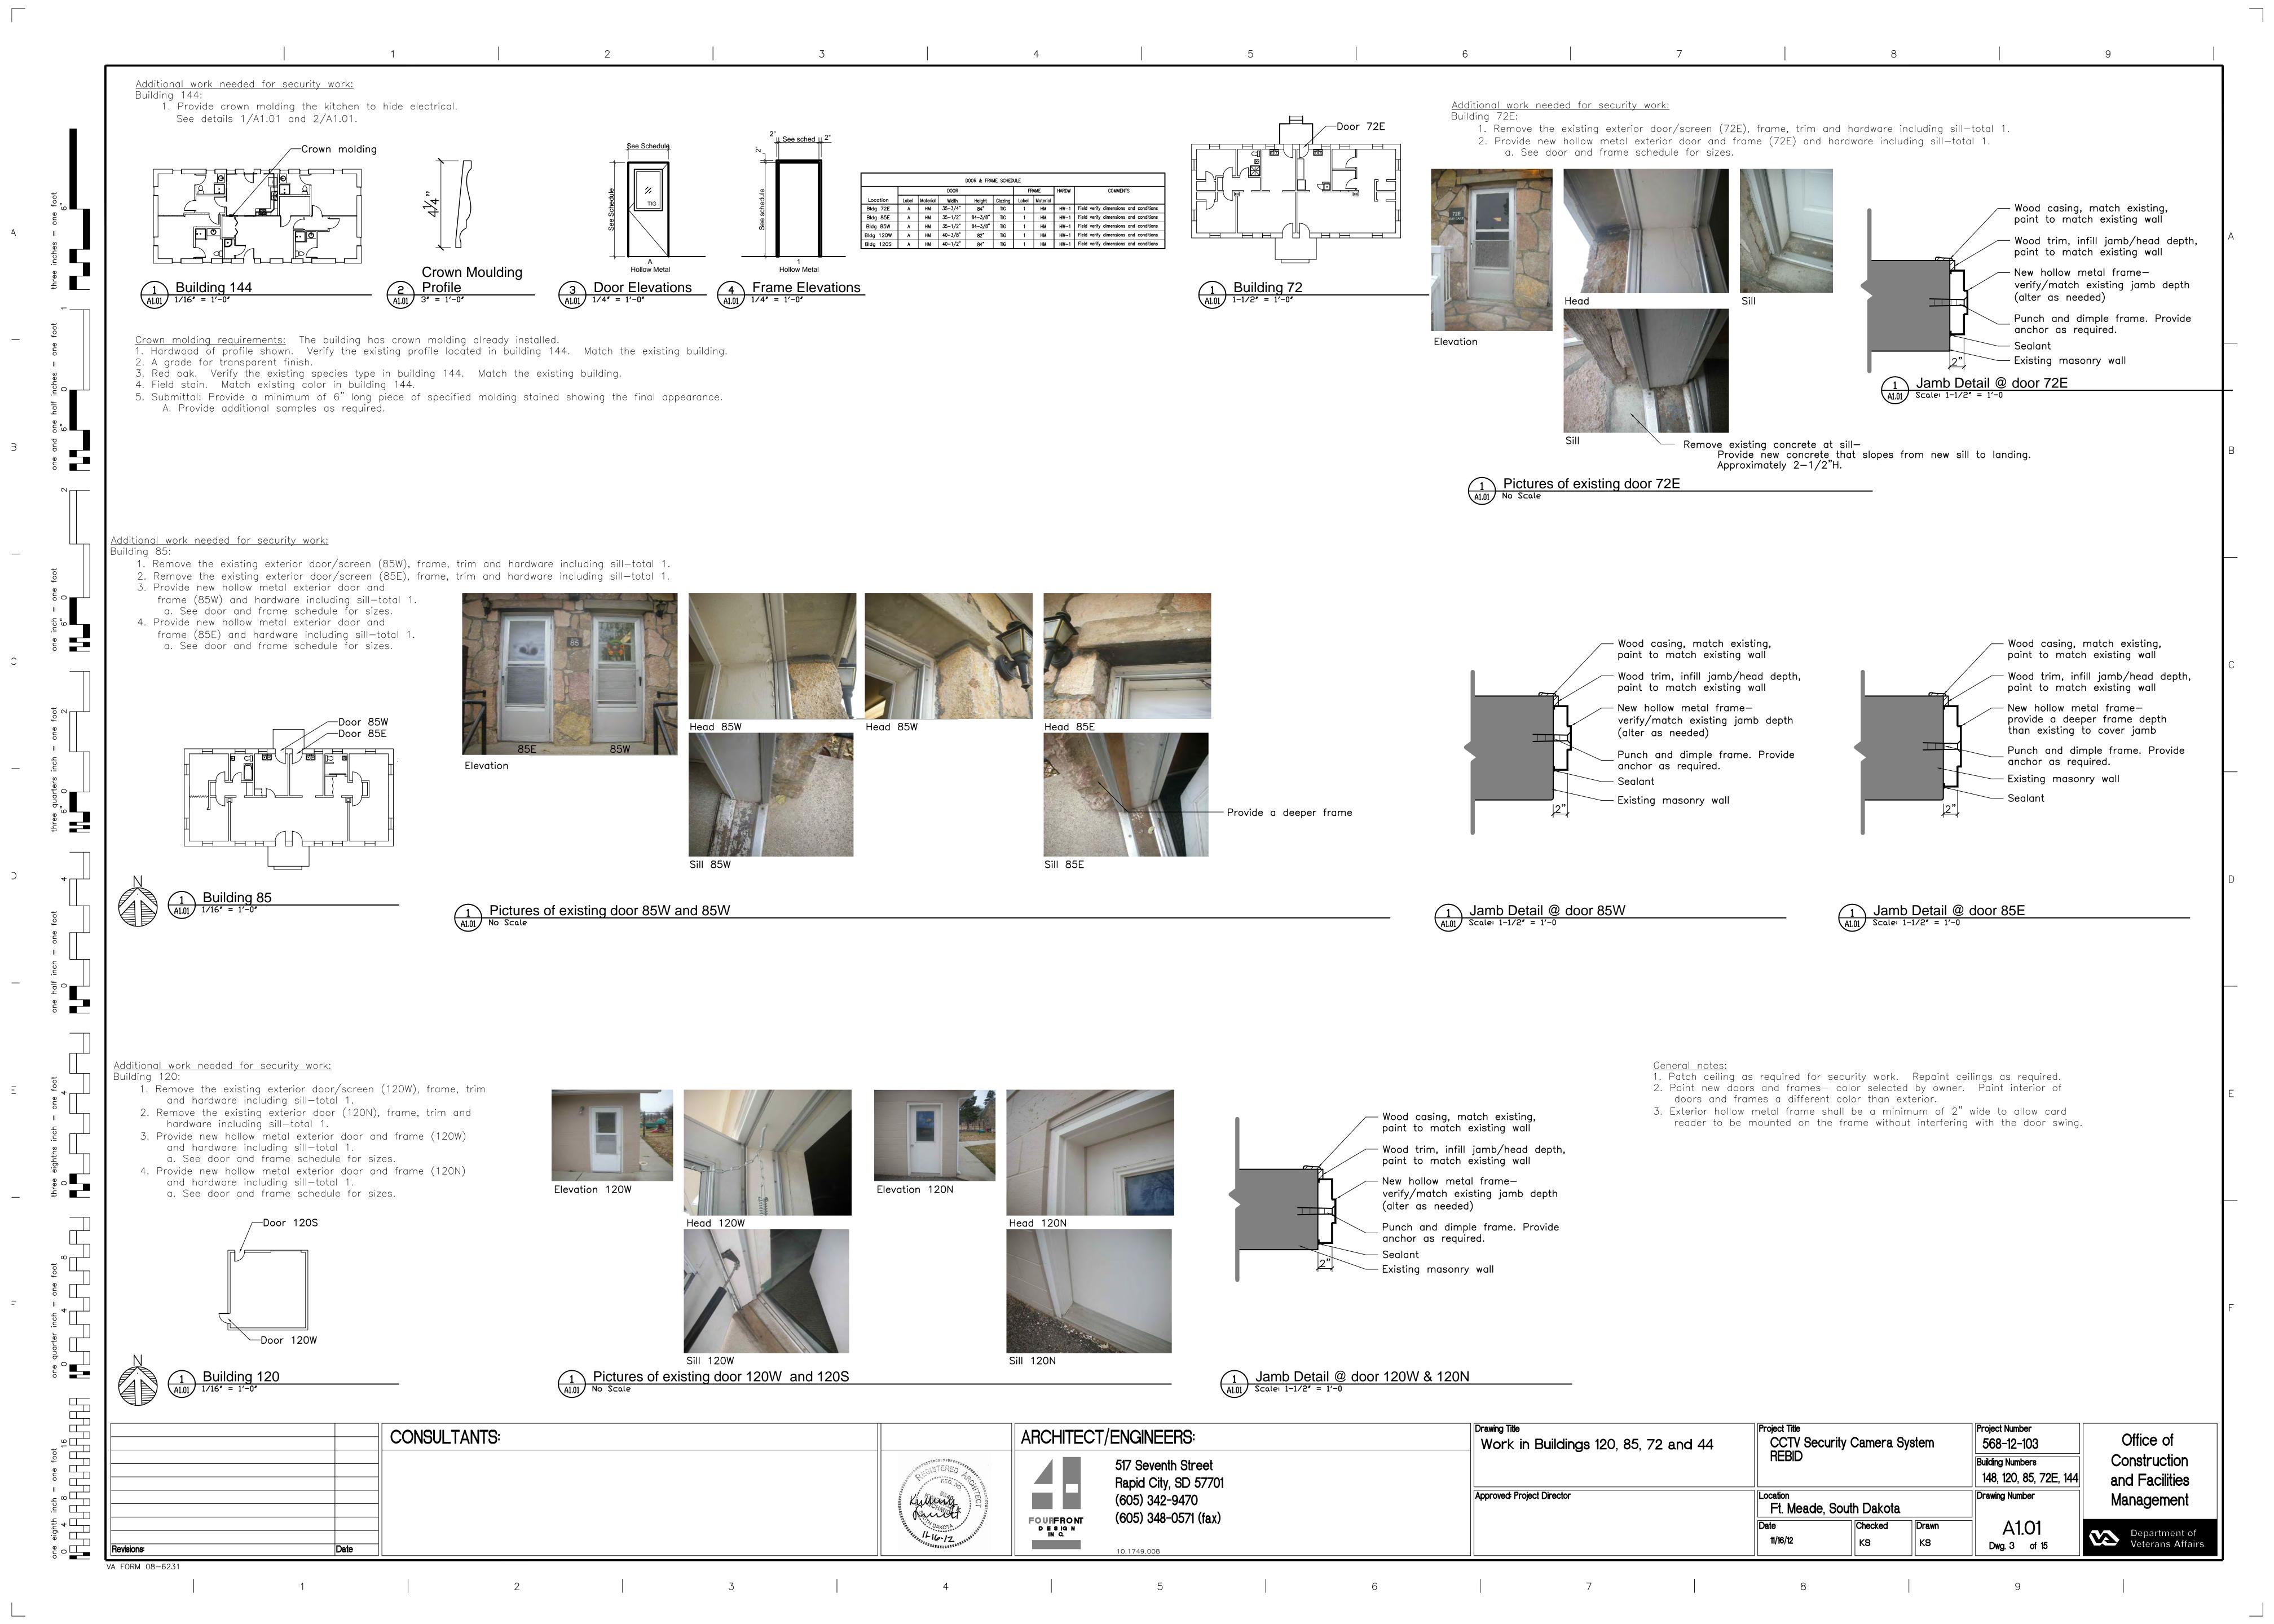

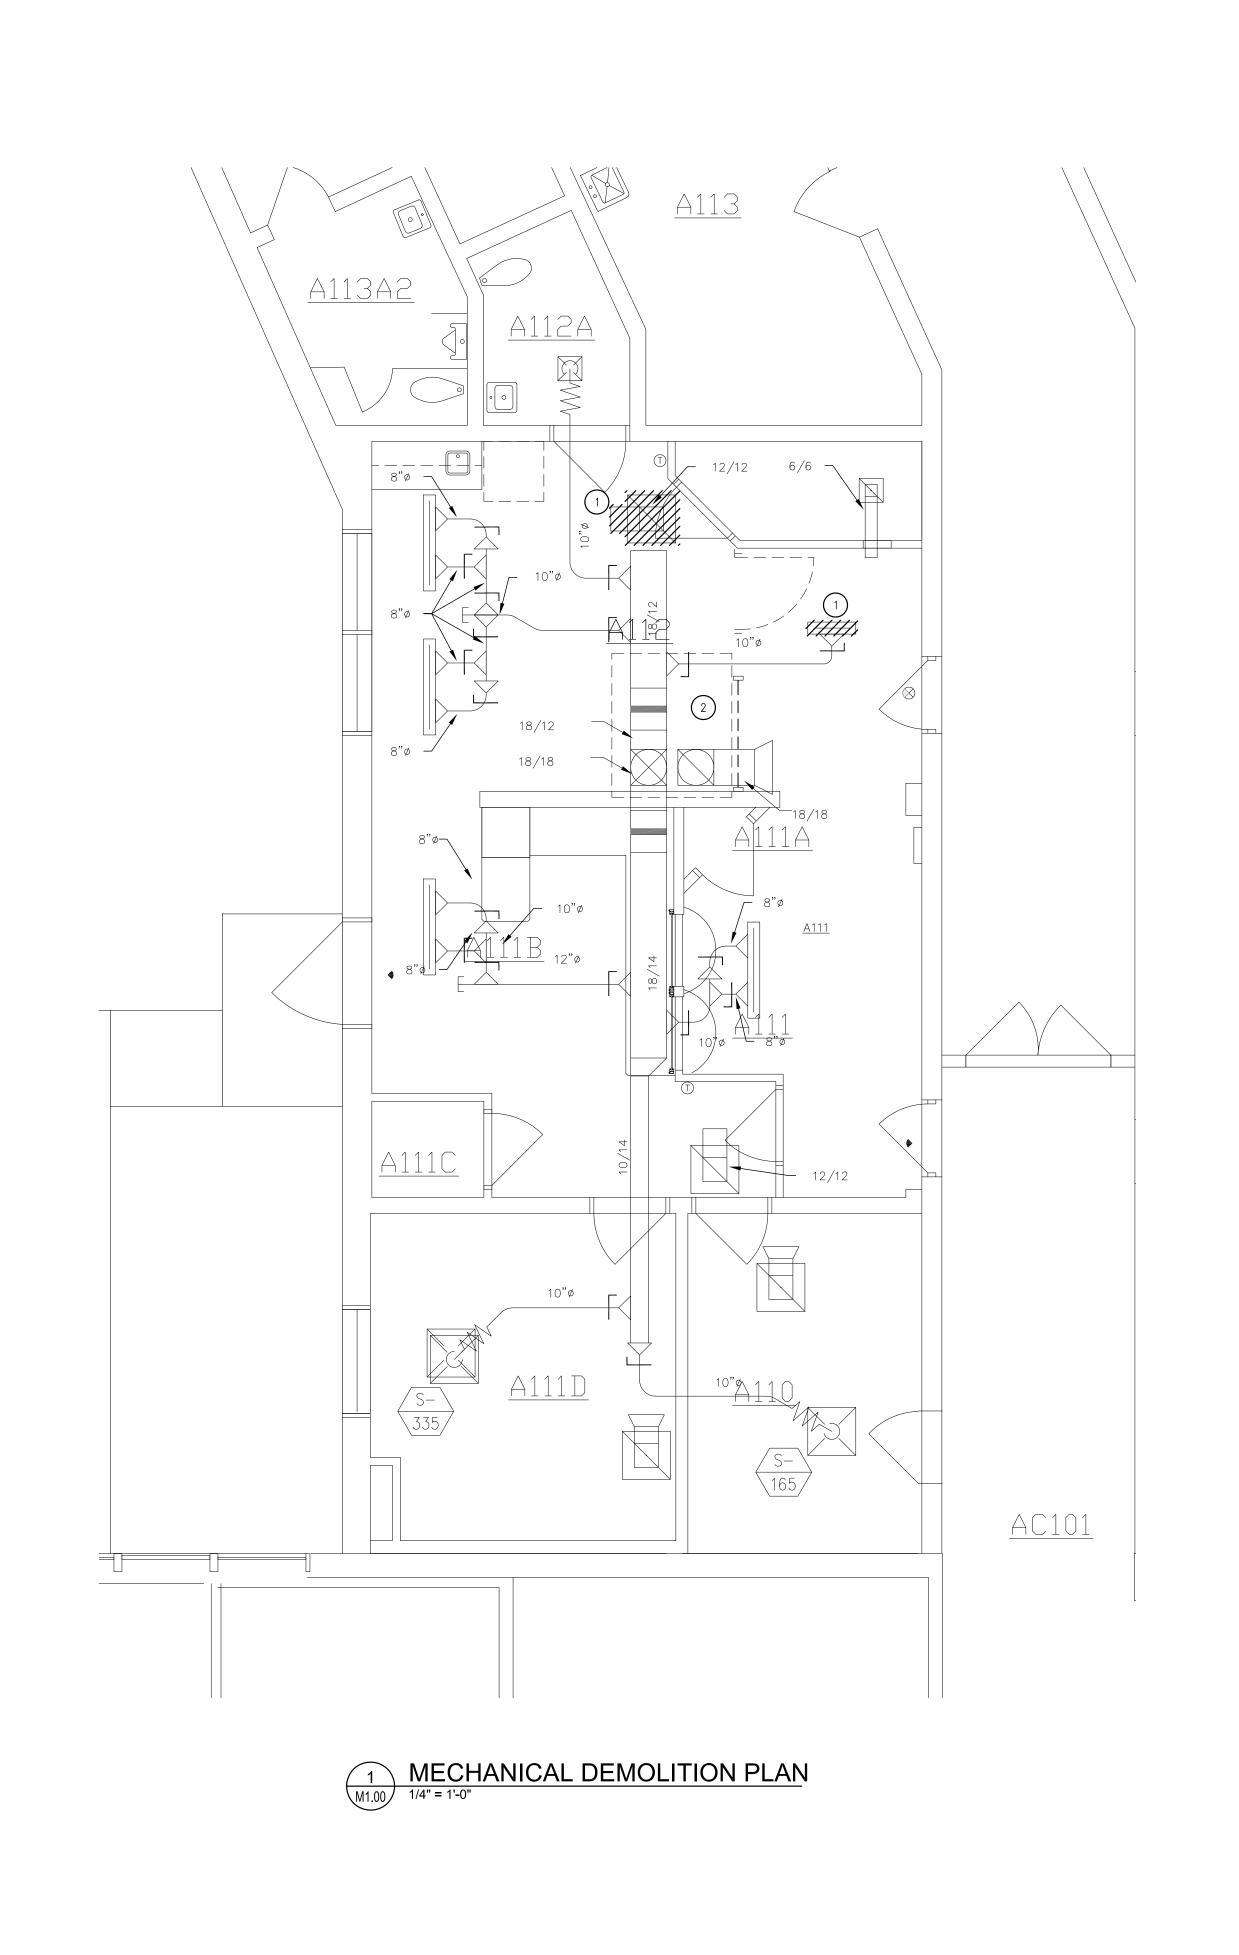

2 3 4

VA FORM 08-6231

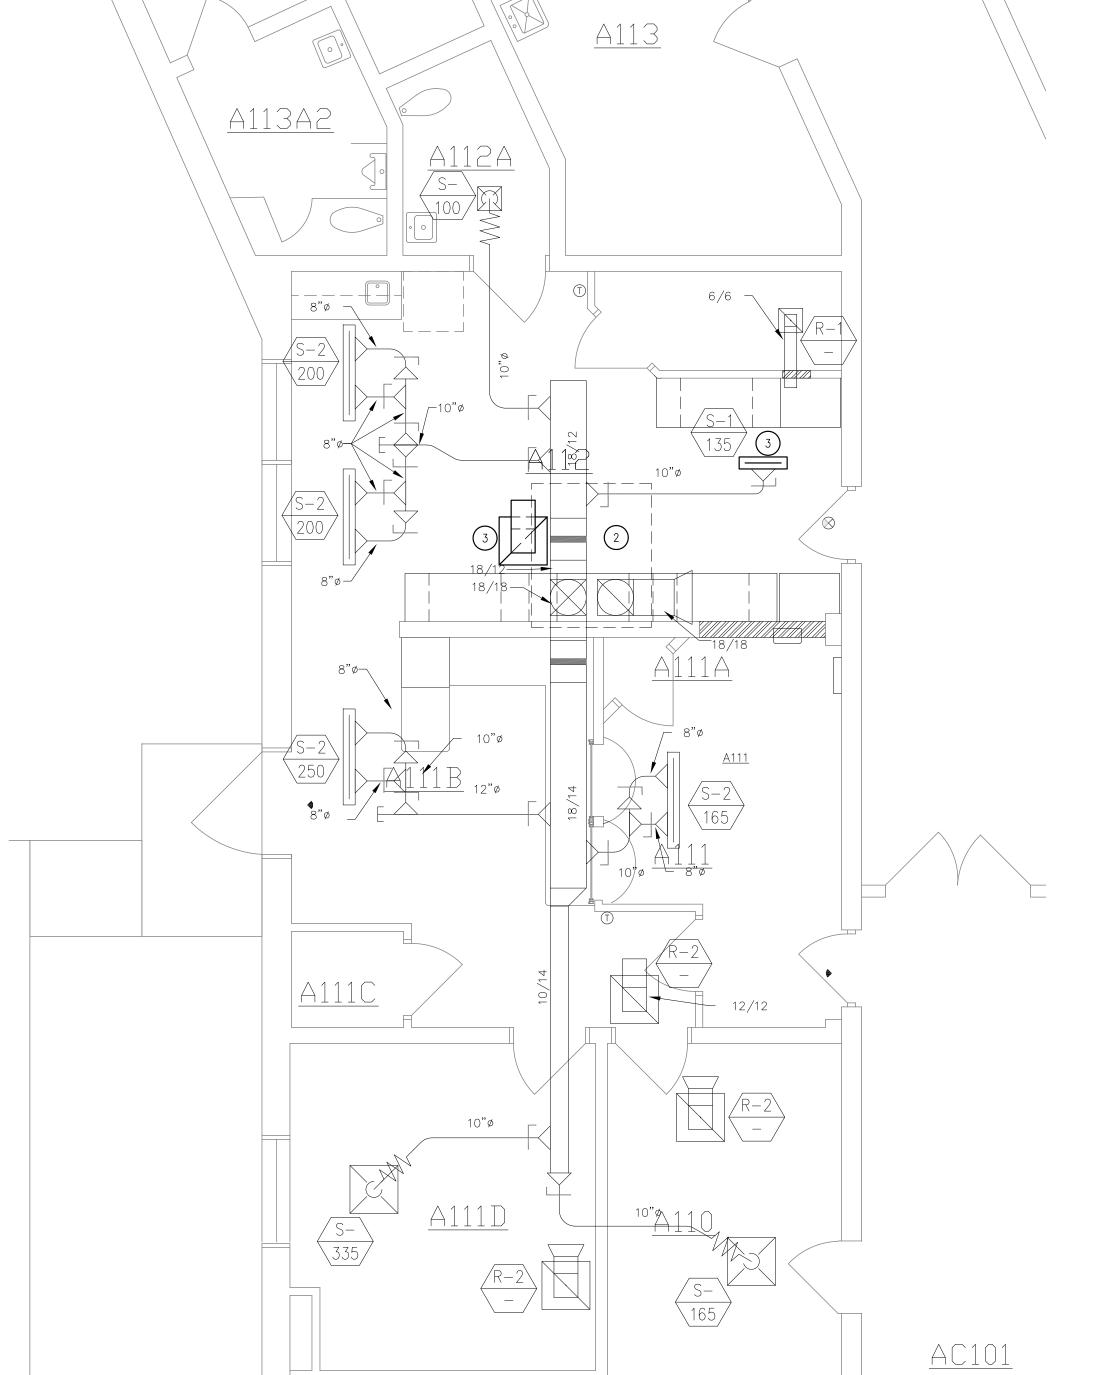

MECHANICAL PLAN


1/4" = 1'-0"

6 | 7

GENERAL MECHANICAL NOTES:

- A. COORDINATE LOCATION OF DUCTWORK WITH STRUCTURE AND OTHER TRADES. INSTALL DUCTWORK AS HIGH AS POSSIBLE.
- B. EXISTING FIRE SPRINKLER SYSTEM TO BE MODIFIED AS REQUIRED TO ACCOMMODATE REMODEL. CONTRACTOR TO FIELD VERIFY EXISTING FIRE SPRINKLER LOCATIONS. REMOVE AND REPLACE ALL EXISTING FIRE SPRINKLER HEADS AND ASSOCIATED BRANCH PIPING NECESSARY TO PROVIDE FIRE SPRINKLER COVERAGE IN ACCORDANCE TO NFPA 13. THE EXISTING FIRE SPRINKLER COVERAGE OUTSIDE OF THE IMMEDIATE AREA OF REMODEL SHALL REMAIN IN SERVICE WITH EXCEPTION TO SHORT OUTAGES REQUIRED FOR DISCONNECTING AND RECONNECTING BRANCH LINES. OUTAGES SHALL BE SCHEDULED WITH THE VA FIRE DEPARTMENT WITH PROTECTION TO NON—CONSTRUCTION AREAS TO BE RESTORED AT THE END OF EACH SHIFT.
- C. COORDINATE PHASING AND REMOVAL OF EXISTING DUCTWORK, ETC., WITH
- D. REMOVE EXISTING GRILLES, REGISTERS, DUCTWORK, PIPING, ETC. WHERE INDICATED BY HATCHING. CAP DUCTWORK DURING CONSTRUCTION.
- E. CONTRACTOR TO CONFIRM SIZE AND LOCATIONS OF EXISTING DUCTWORK.
- F. REBALANCE SYSTEM TO CFM VALUES AS INDICATED.

 SPECIFIC MECHANICAL NOTES: (#)
- 1. REMOVE EXISTING GRILLES AND DIFFUSERS AND RETAIN FOR RELOCATION.
 REFER TO SHEET 2/M1.0 FOR NEW LOCATION.
- 2. EXISTING ROOF TOP UNIT CAPACITY IS CAPABLE OF AN ADDITIONAL 15MBH/5KW OF ADDITIONAL COOLING LOAD WITHIN THE SPACE. UNIT IS COOLING ONLY WITH HYDRONIC REHEAT COILS FOR TWO ZONES.
- 3. INSTALL RELOCATED DIFFUSER WITHIN NEW CEILING GRID. ALL NEW DUCTWORK SHALL MEET THE REQUIREMENTS OF SMACNA.

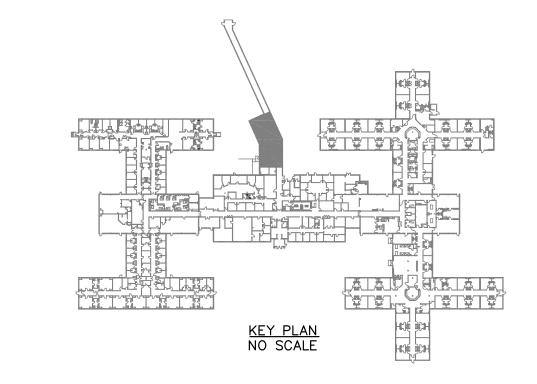


9


8

one eighth inch = one foot

0 4 8 16 Drawing Title

MECHANICAL PLANS Project Title
CCTV Security Camera System Project Number ARCHITECT/ENGINEERS: CONSULTANTS: Office of 568-12-103 **REBID** Construction Building Number WPE #BR11046 517 Seventh Street 148 and Facilities Rapid City, SD 57701 8462
MICHAEL SEAN
HEINRICH
HEINRICH
HEINRICH
HEINRICH
HEINRICH Approved: Project Director Drawing Number Management (605) 342-9470 Ft. Meade, South Dakota 1750 RAND ROAD • RAPID CITY, SD 57702 PHONE: (605) 348-7455 • FAX: (605) 348-9445 (605) 348-0571 (fax) FOURFRONT DESIGN INC. www.westplainsengineering.com Department of Veterans Affairs RAPID CITY, SD ■ SIOUX FALLS, SD ■ CASPER, WY ■ CEDAR RAPIDS, IA 11/16/12 MSH Dwg. 1 of 15 10.1749.008

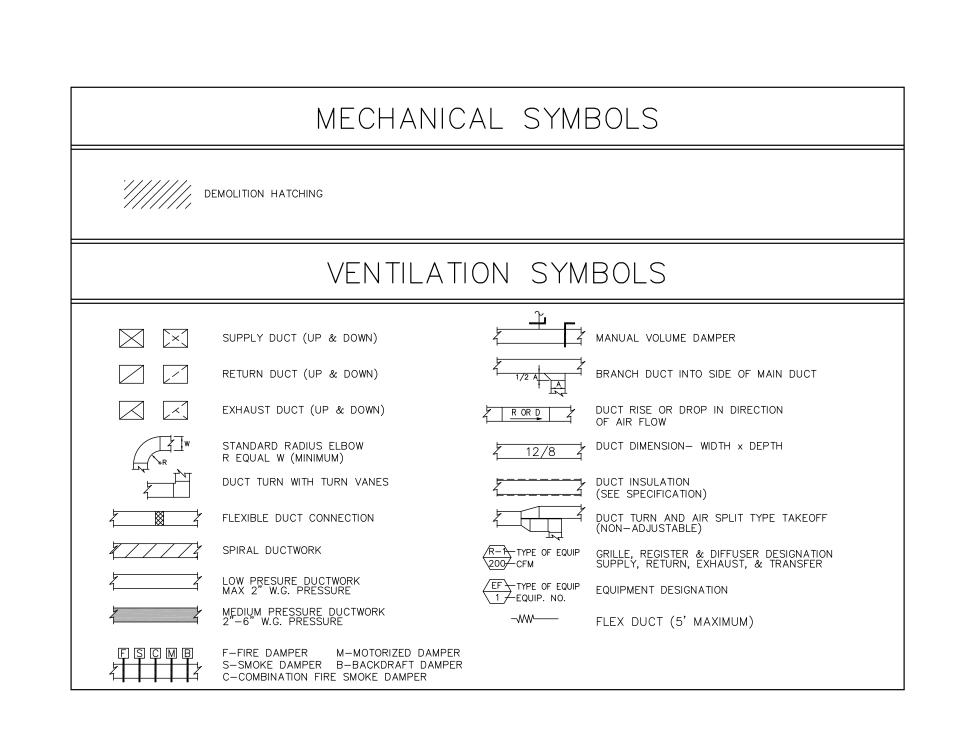

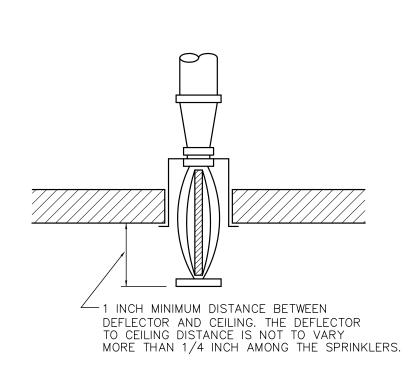



RECESSED SPRINKLER DETAIL NO SCALE

ACCESS PANEL DETAIL

NO SCALE

2 3 4

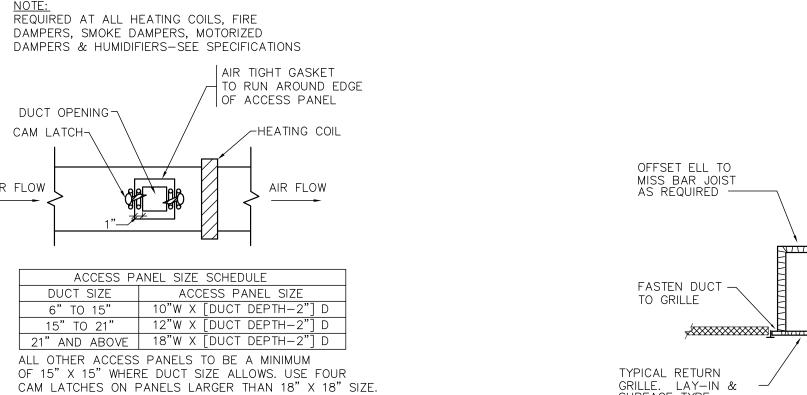

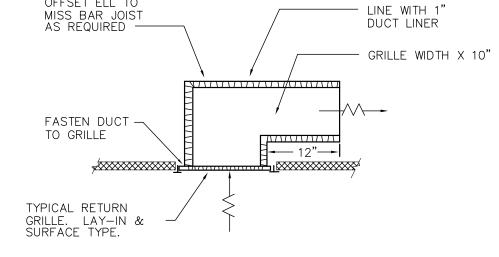

ROUND DUCT TAKE-OFF DETAIL

FLOW

NO SCALE

CONICAL BELLMOUTH W/TWIST IN FITTING

MAN. DAMPER WITH HANDLE & LOCK-NUT

S.S. CLAMP-MED. VELOCITY
NYLON STRAP-LOW VELOCITY

6 7

8

INSULATED RETURN ELBOW DETAIL NO SCALE


Drawing Title


MECHANICAL DETAILS AND SYMBOLS Project Title
CCTV Security Camera System Project Number CONSULTANTS: ARCHITECT/ENGINEERS: Office of 568-12-103 **REBID** Construction Building Number WPE #BR11046 517 Seventh Street 148 and Facilities Rapid City, SD 57701 8462
MICHAEL SEAN
HEINRICH
HEINRICH
HEINRICH
HEINRICH
HEINRICH Approved: Project Director Drawing Number Management (605) 342-9470 Ft. Meade, South Dakota 1750 RAND ROAD • RAPID CITY, SD 57702 PHONE: (605) 348-7455 • FAX: (605) 348-9445 (605) 348-0571 (fax) FOURFRONT DESIGN INC. www.westplainsengineering.com Department of Veterans Affairs RAPID CITY, SD ■ SIOUX FALLS, SD ■ CASPER, WY ■ CEDAR RAPIDS, IA MSH Dwg. 1 of 15 10.1749.008

one eighth inch = one foot

0 4 8 16

VA FORM 08-6231

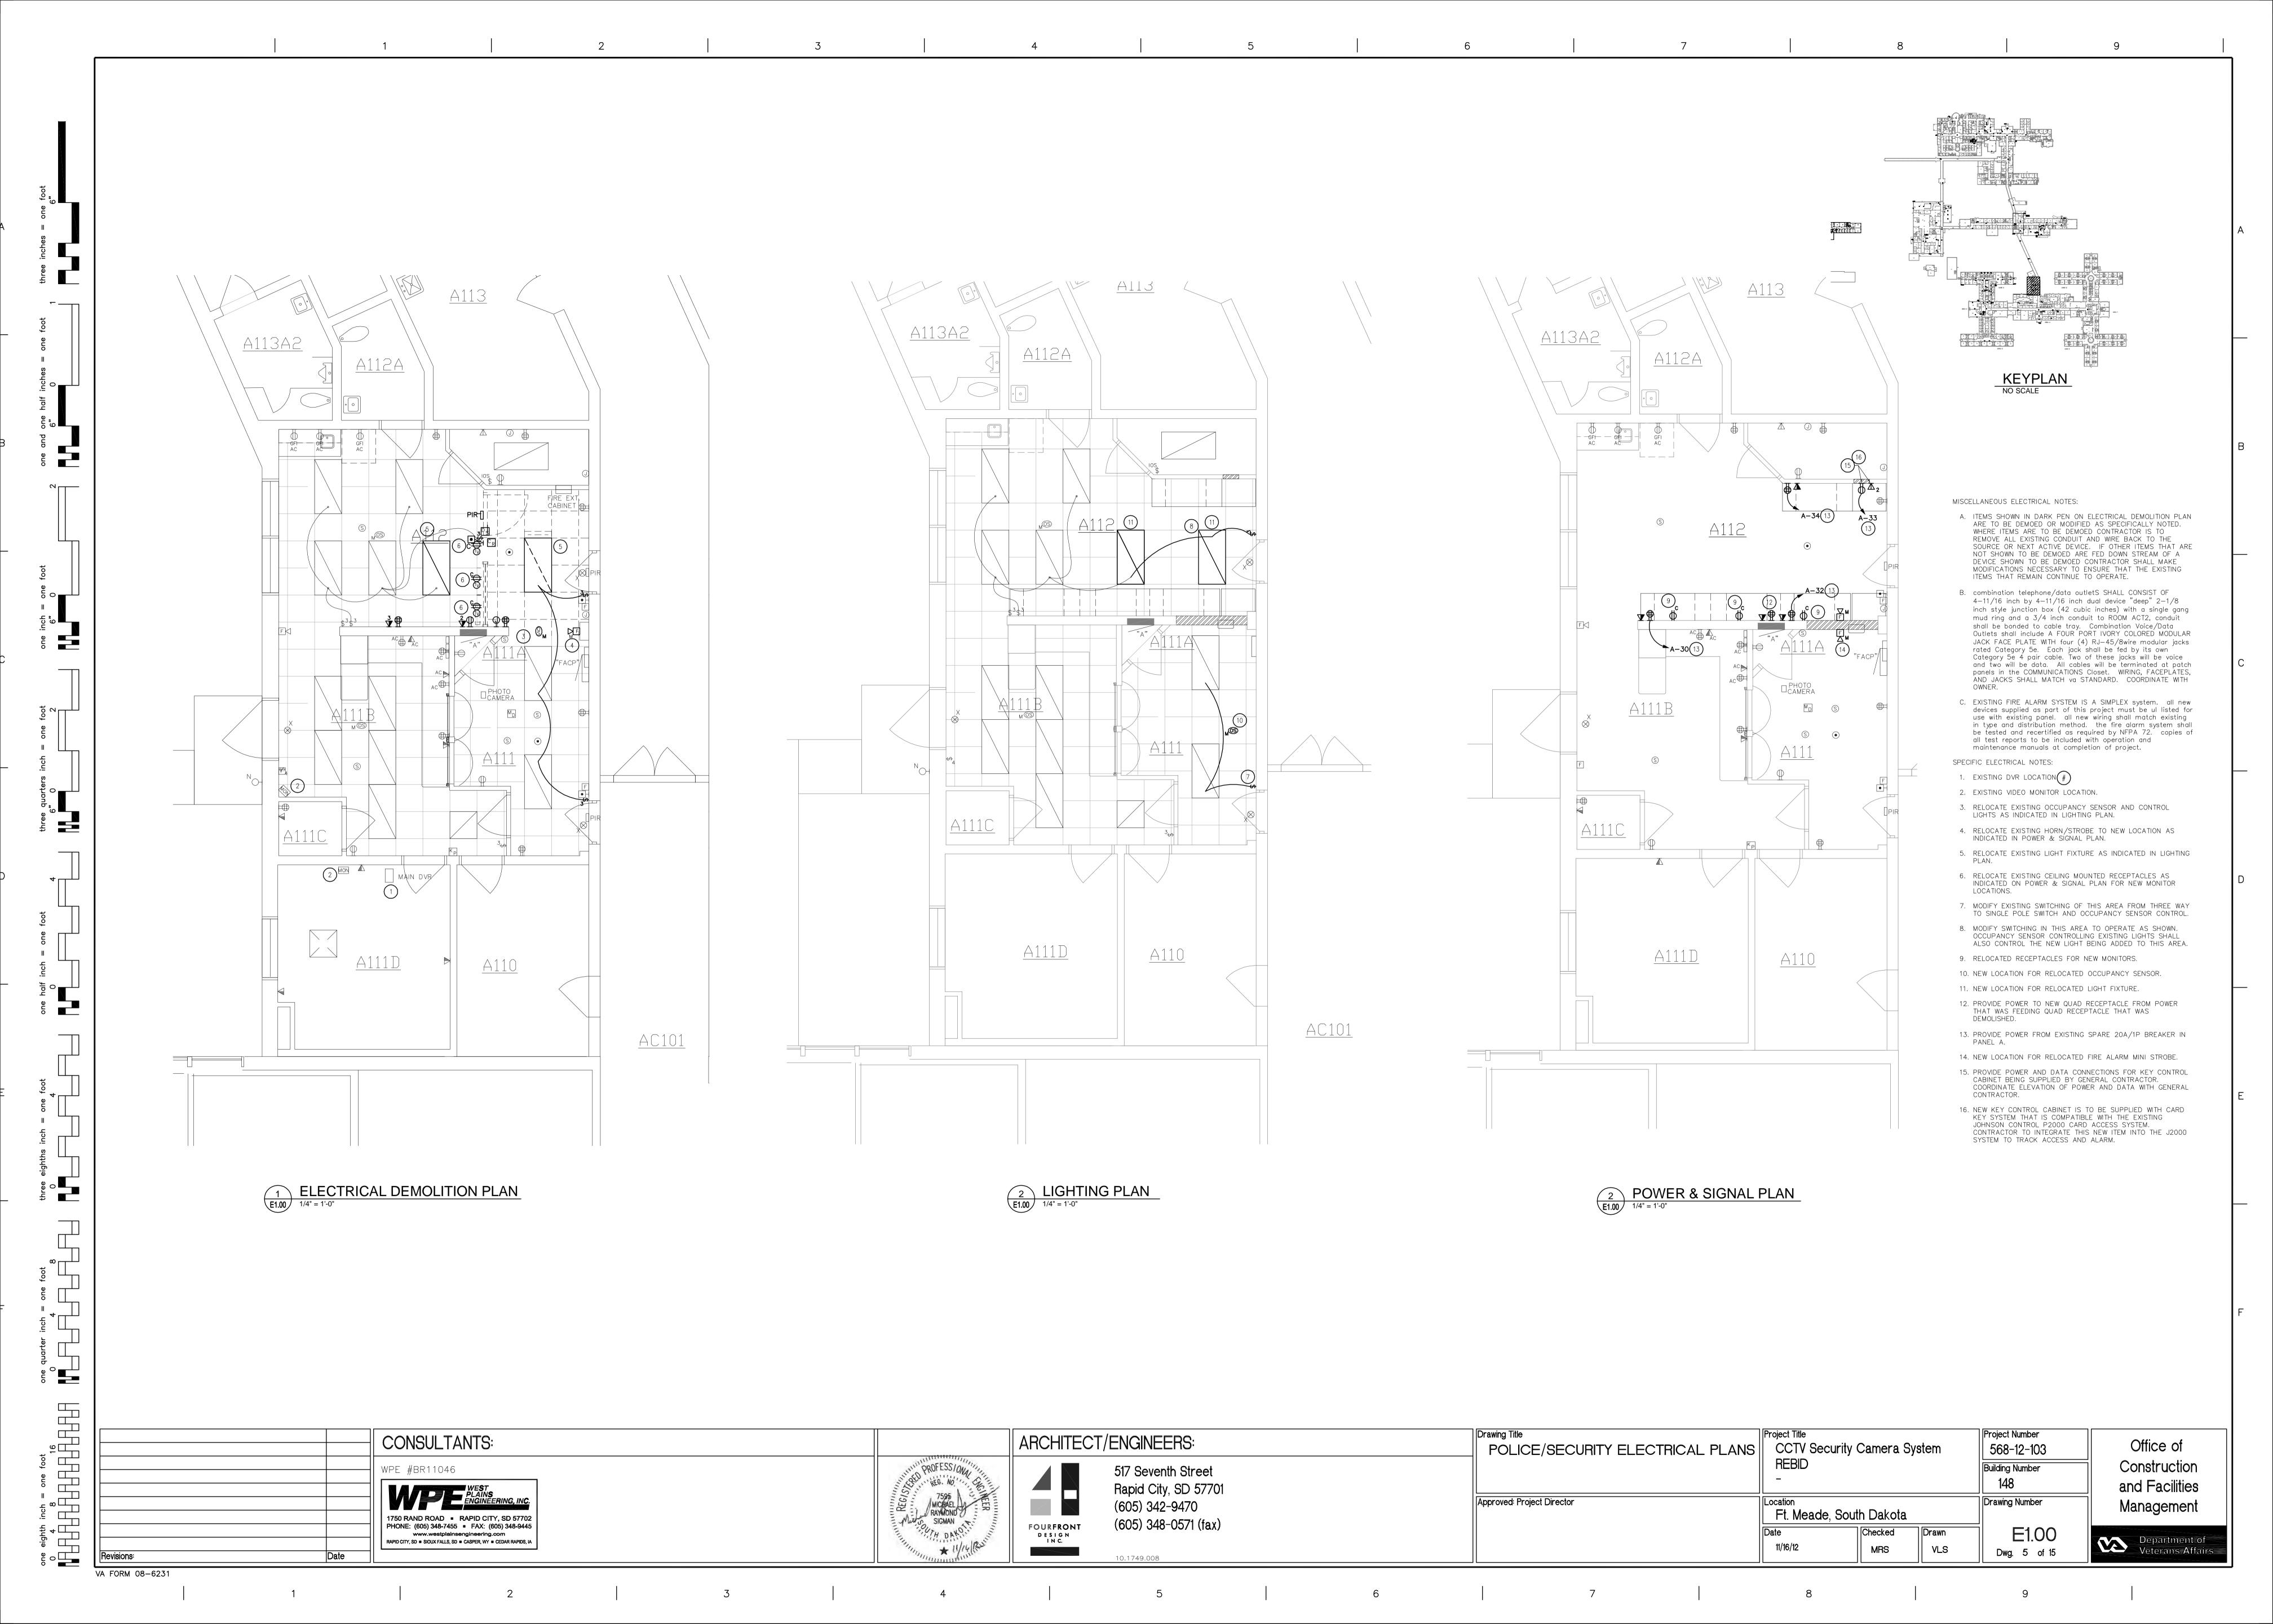

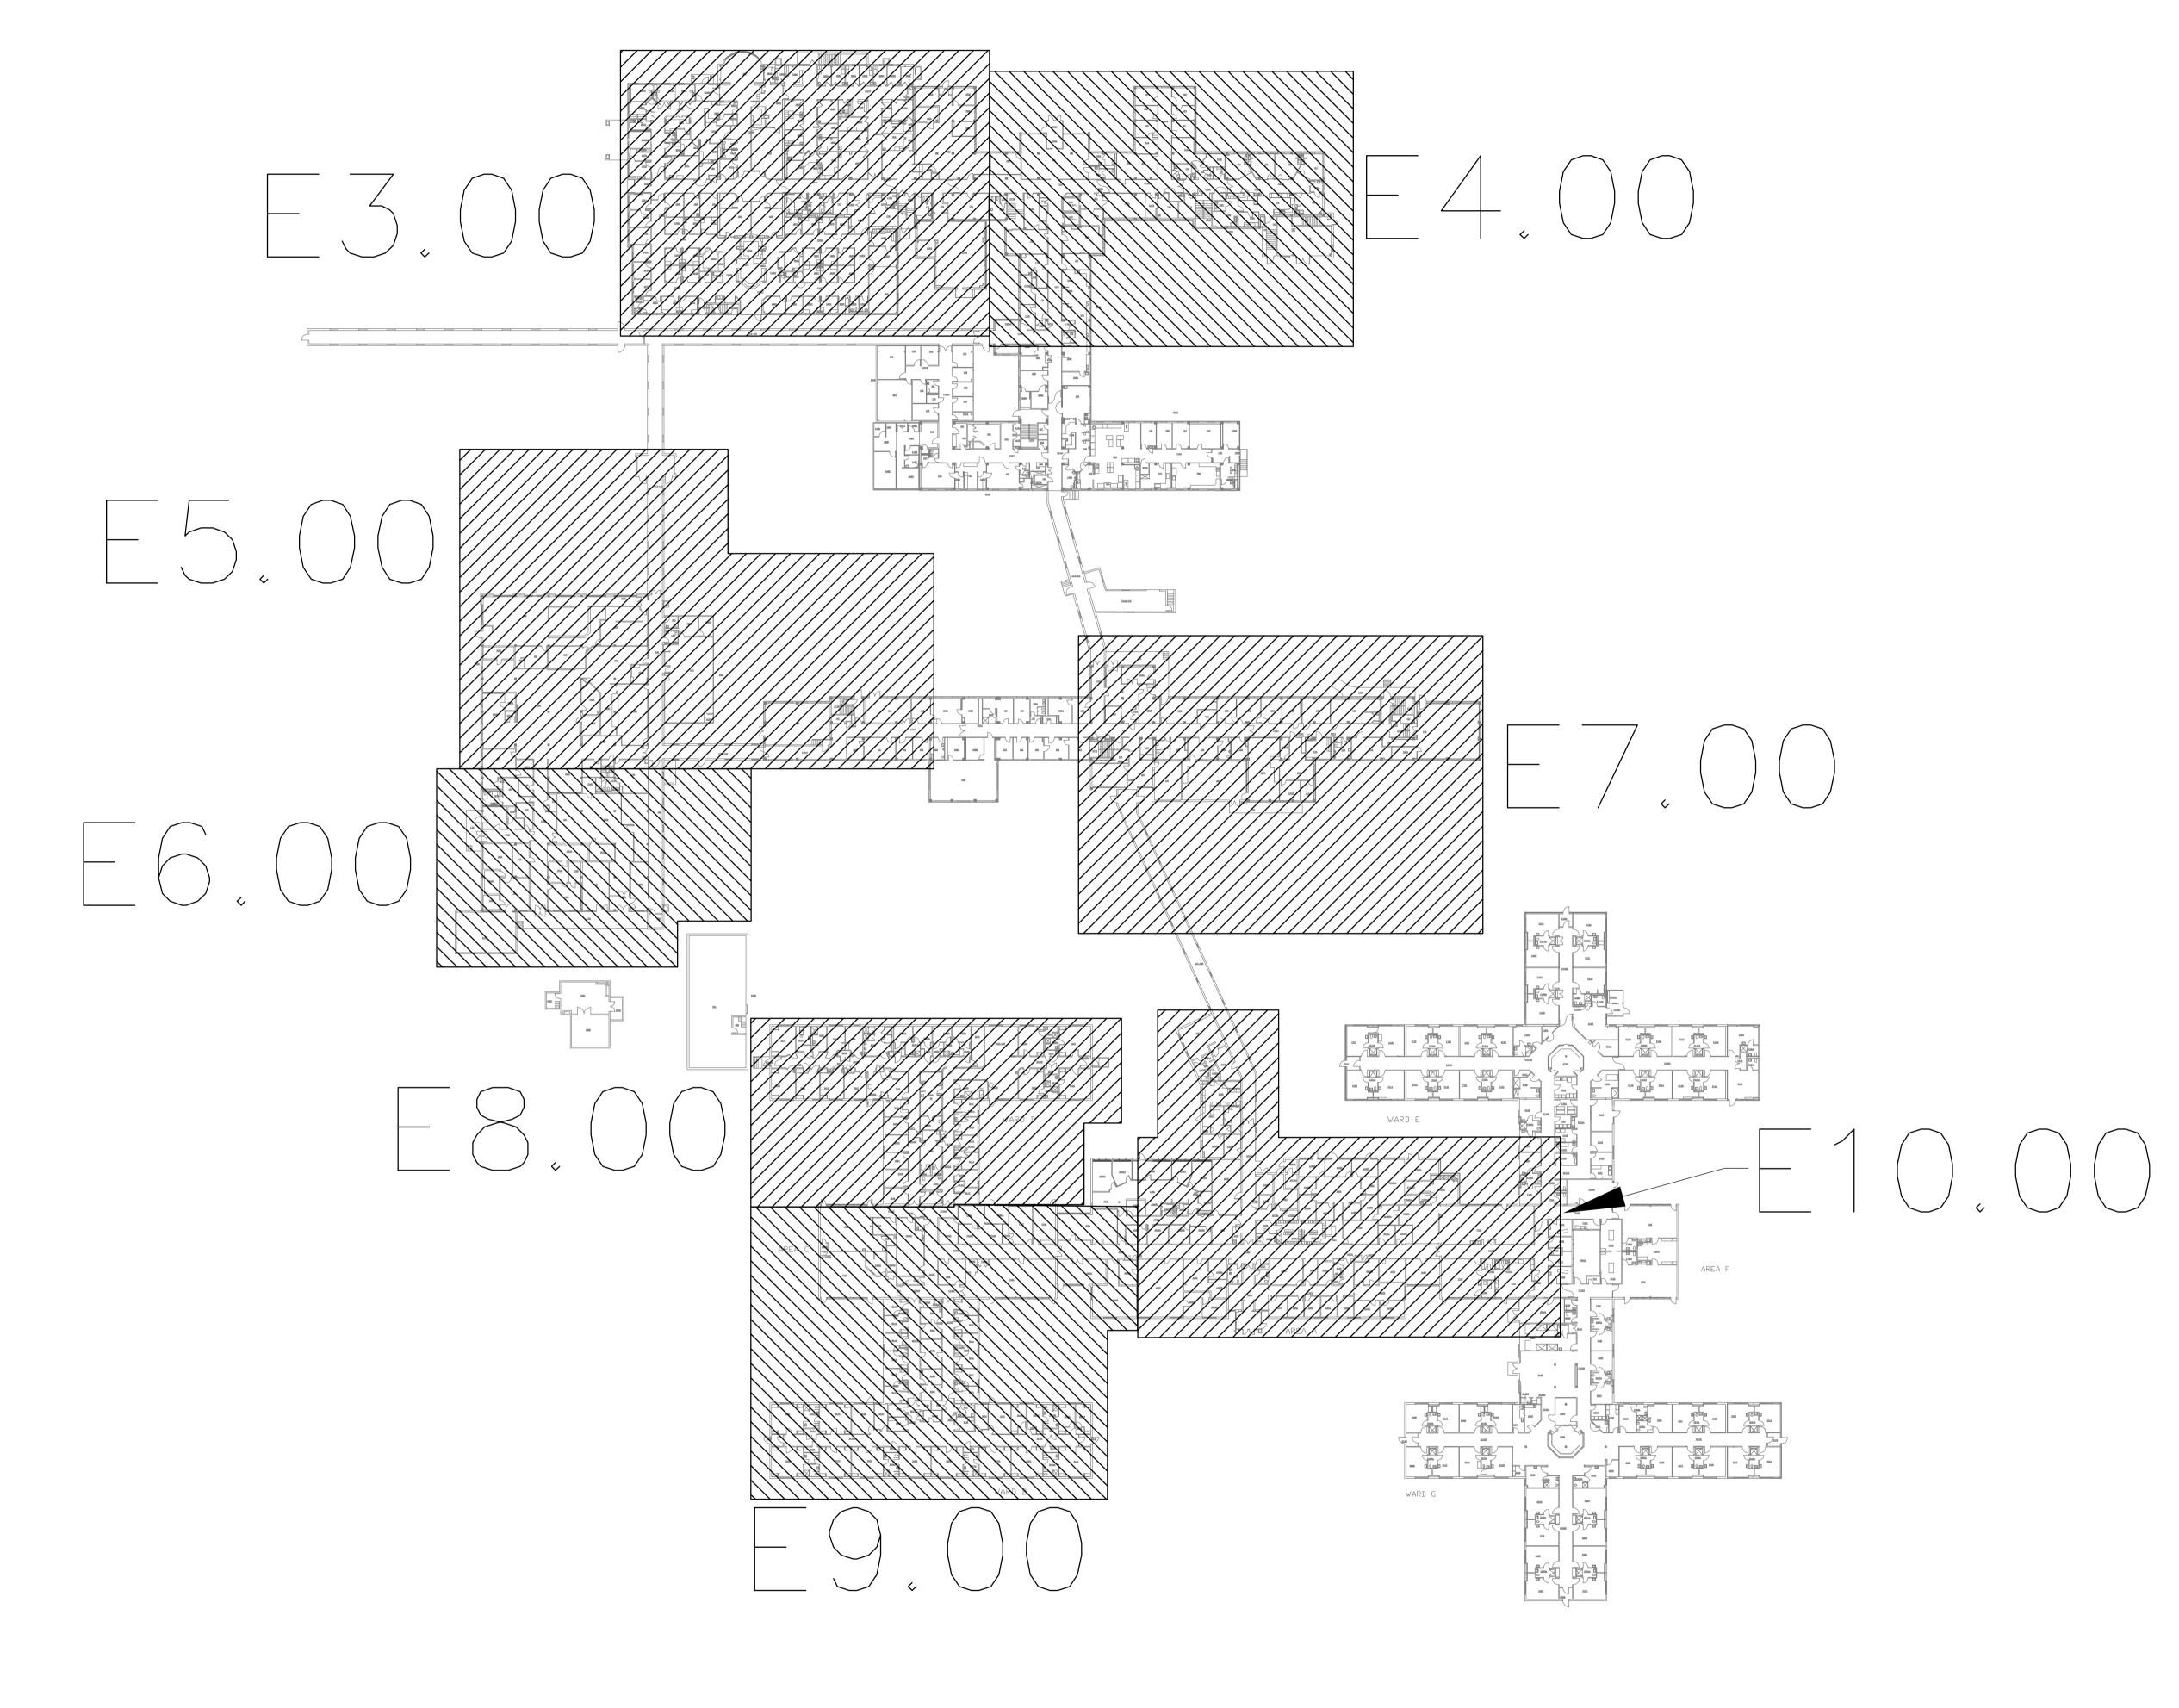



6 | 7 |

9


Drawing Title
OVERALL CCTV/SECURITY PLAN - SHEET INDEX Project Title
CCTV Security Camera System Project Number ARCHITECT/ENGINEERS: CONSULTANTS: Office of 568-12-103 REBID Construction Building Number 517 Seventh Street WPE #BR11046 113 and Facilities Rapid City, SD 57701 WEST PLAINS ENGINEERING, INC. Approved: Project Director Drawing Number (605) 342-9470 Management Ft. Meade, South Dakota 1750 RAND ROAD • RAPID CITY, SD 57702 PHONE: (605) 348-7455 • FAX: (605) 348-9445 (605) 348-0571 (fax) FOURFRONT DESIGN INC. E2.00 www.westplainsengineering.com


RAPID CITY, SD = SIOUX FALLS, SD = CASPER, WY = CEDAR RAPIDS, IA Department of Veterans Affairs 11/16/12 MRS VLS Dwg. 6 of 15 10.1749.008 Revisions: VA FORM 08-6231


3 4


one eighth inch = one foot

0 4 8 16

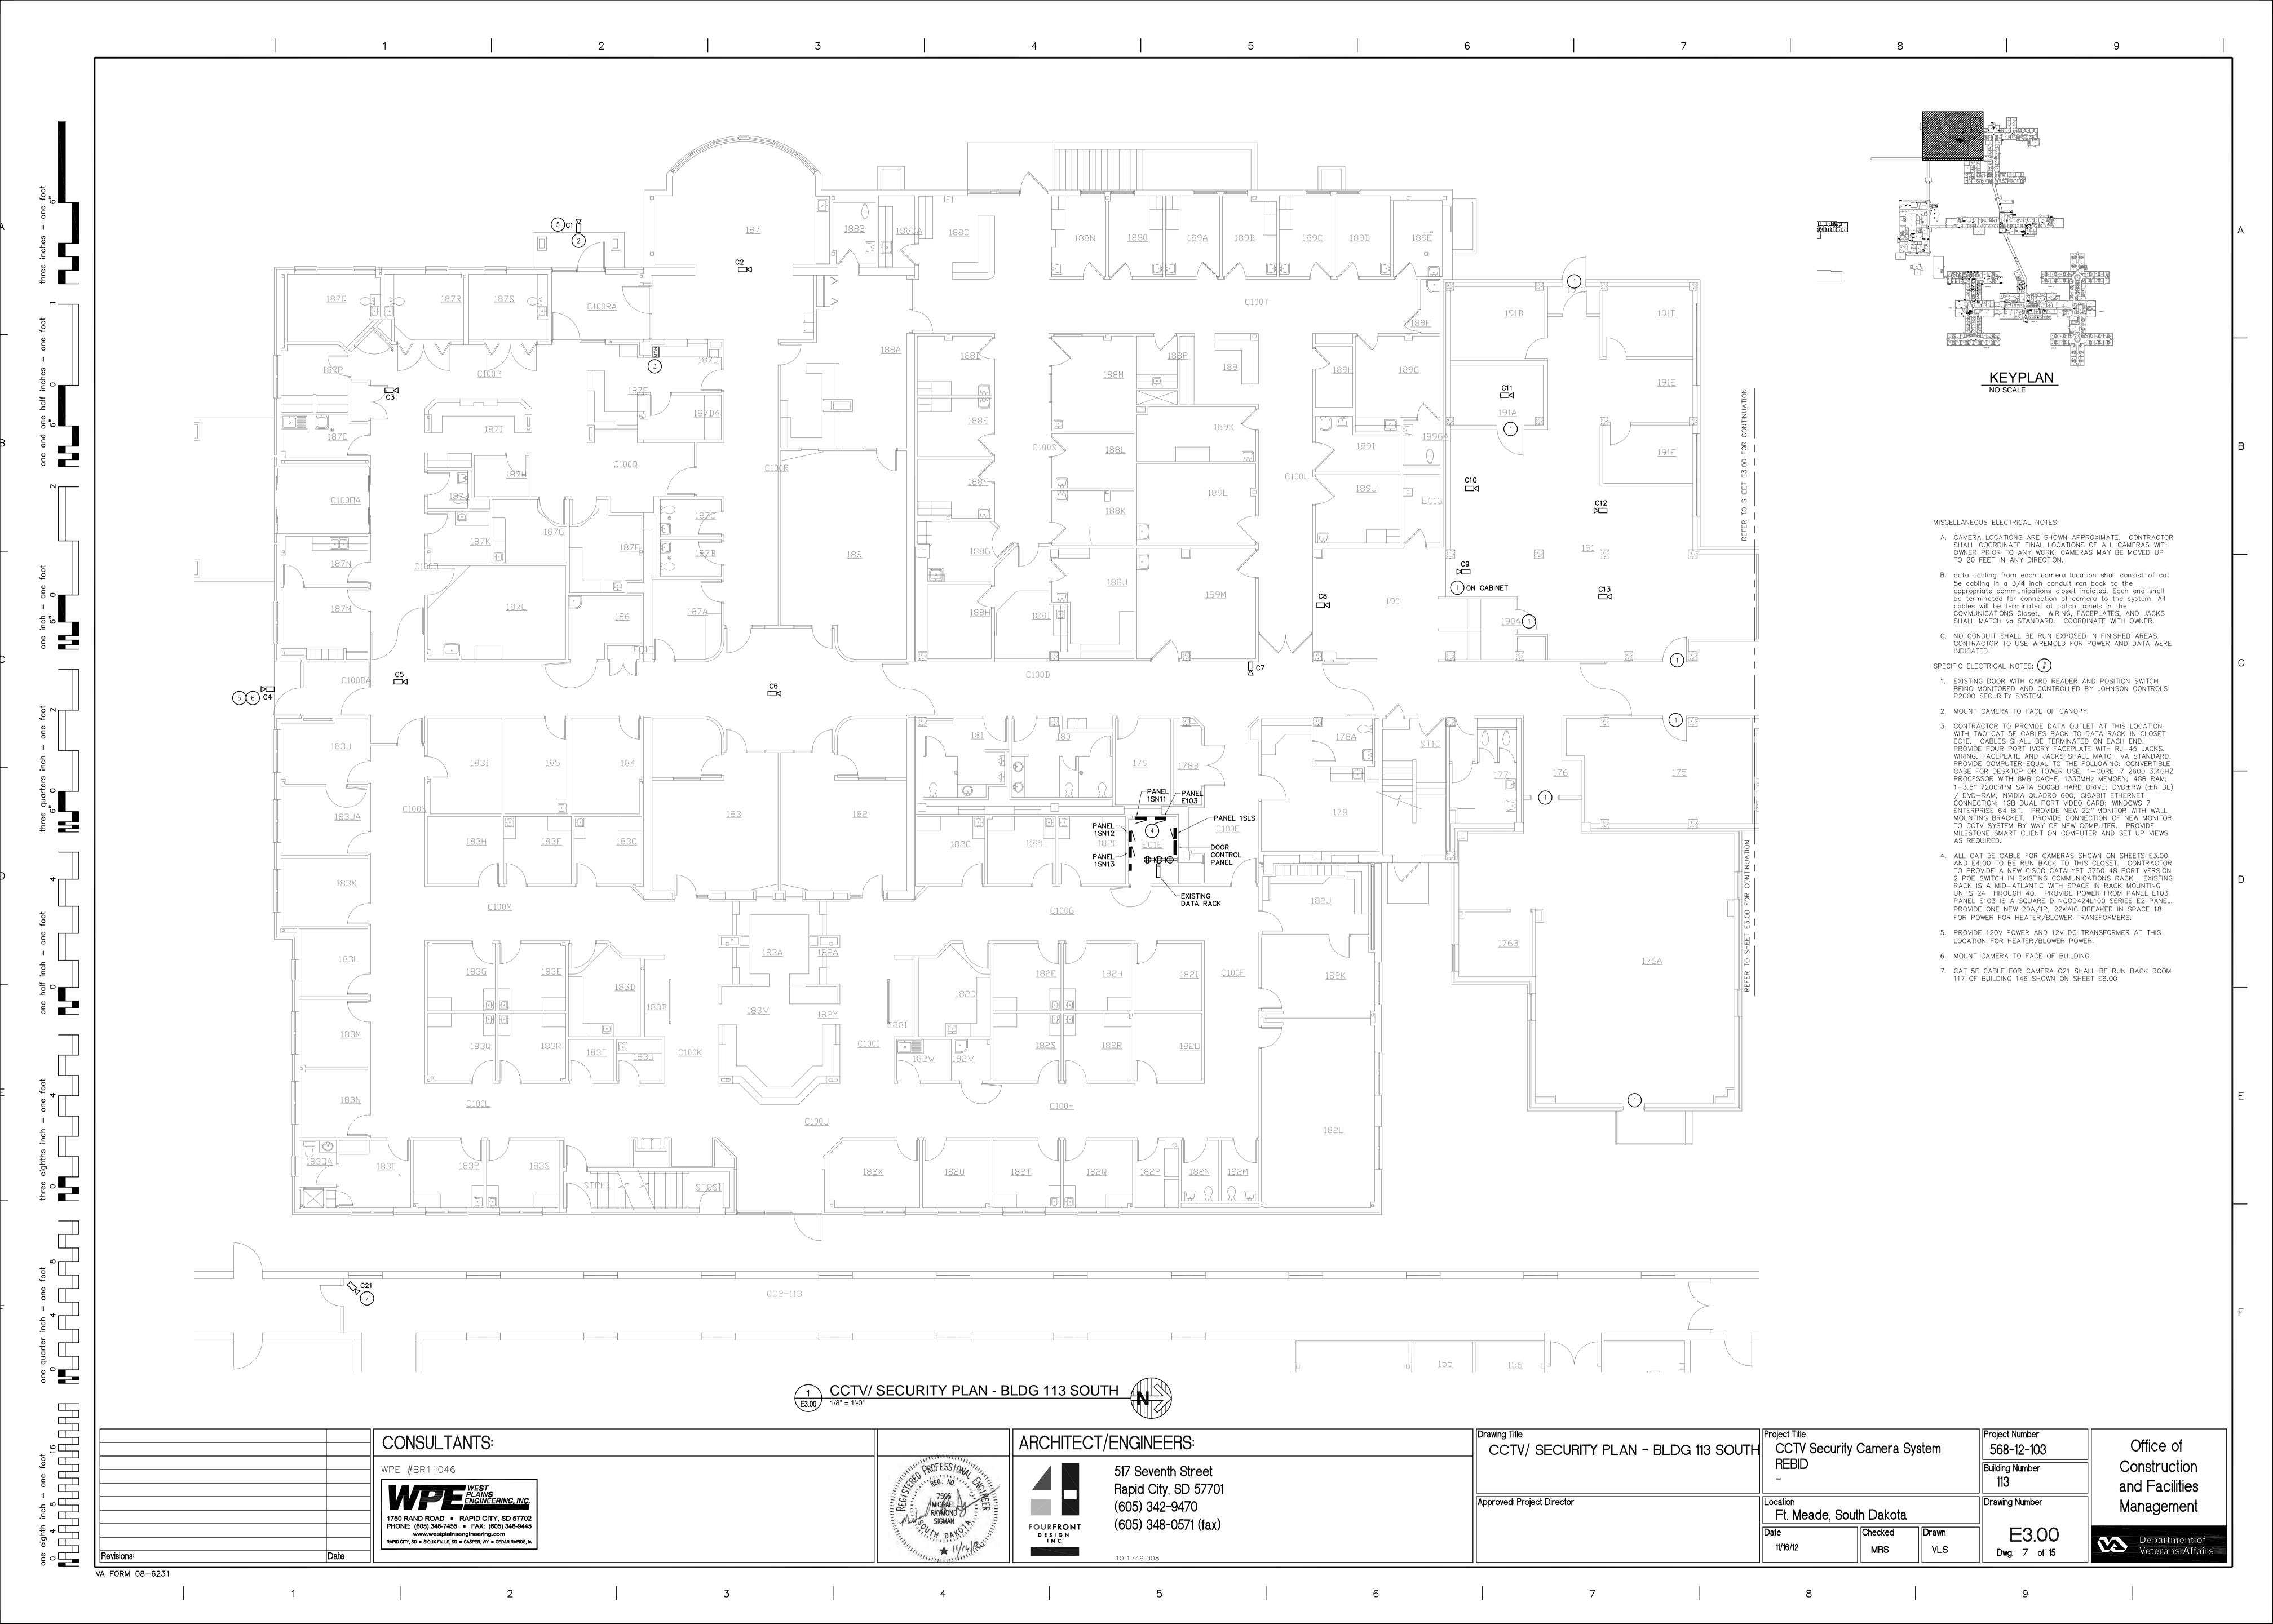

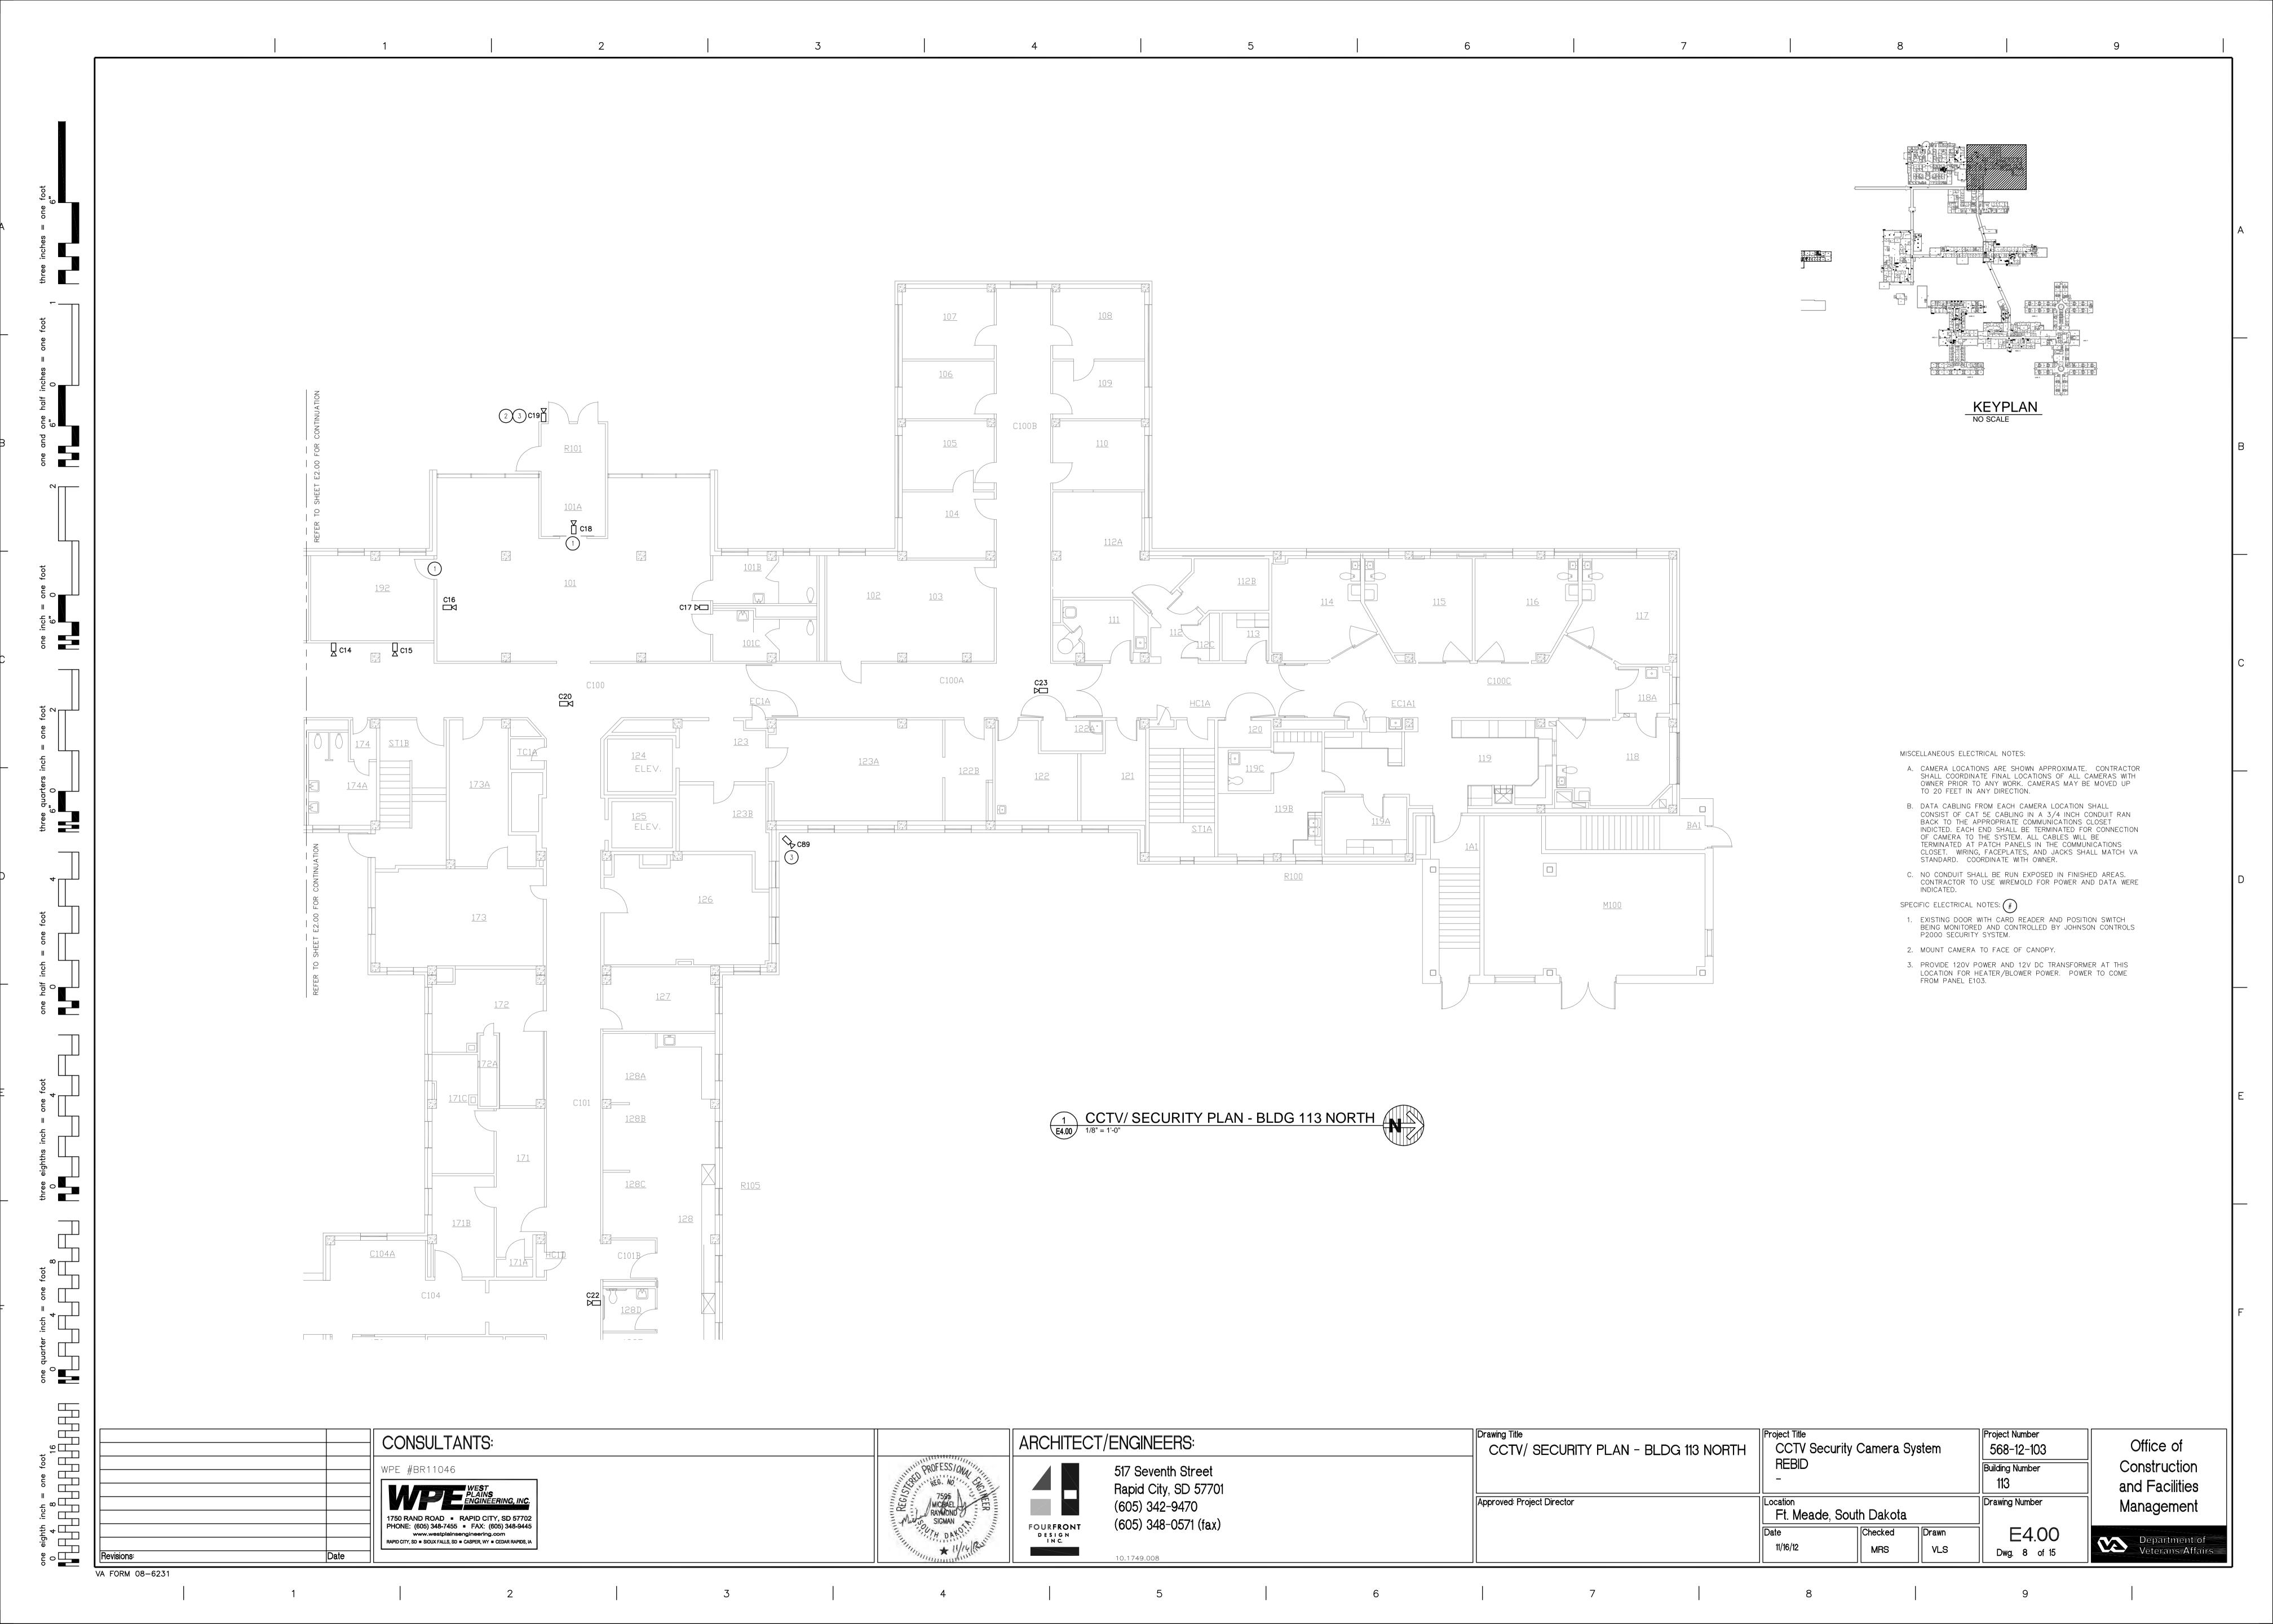

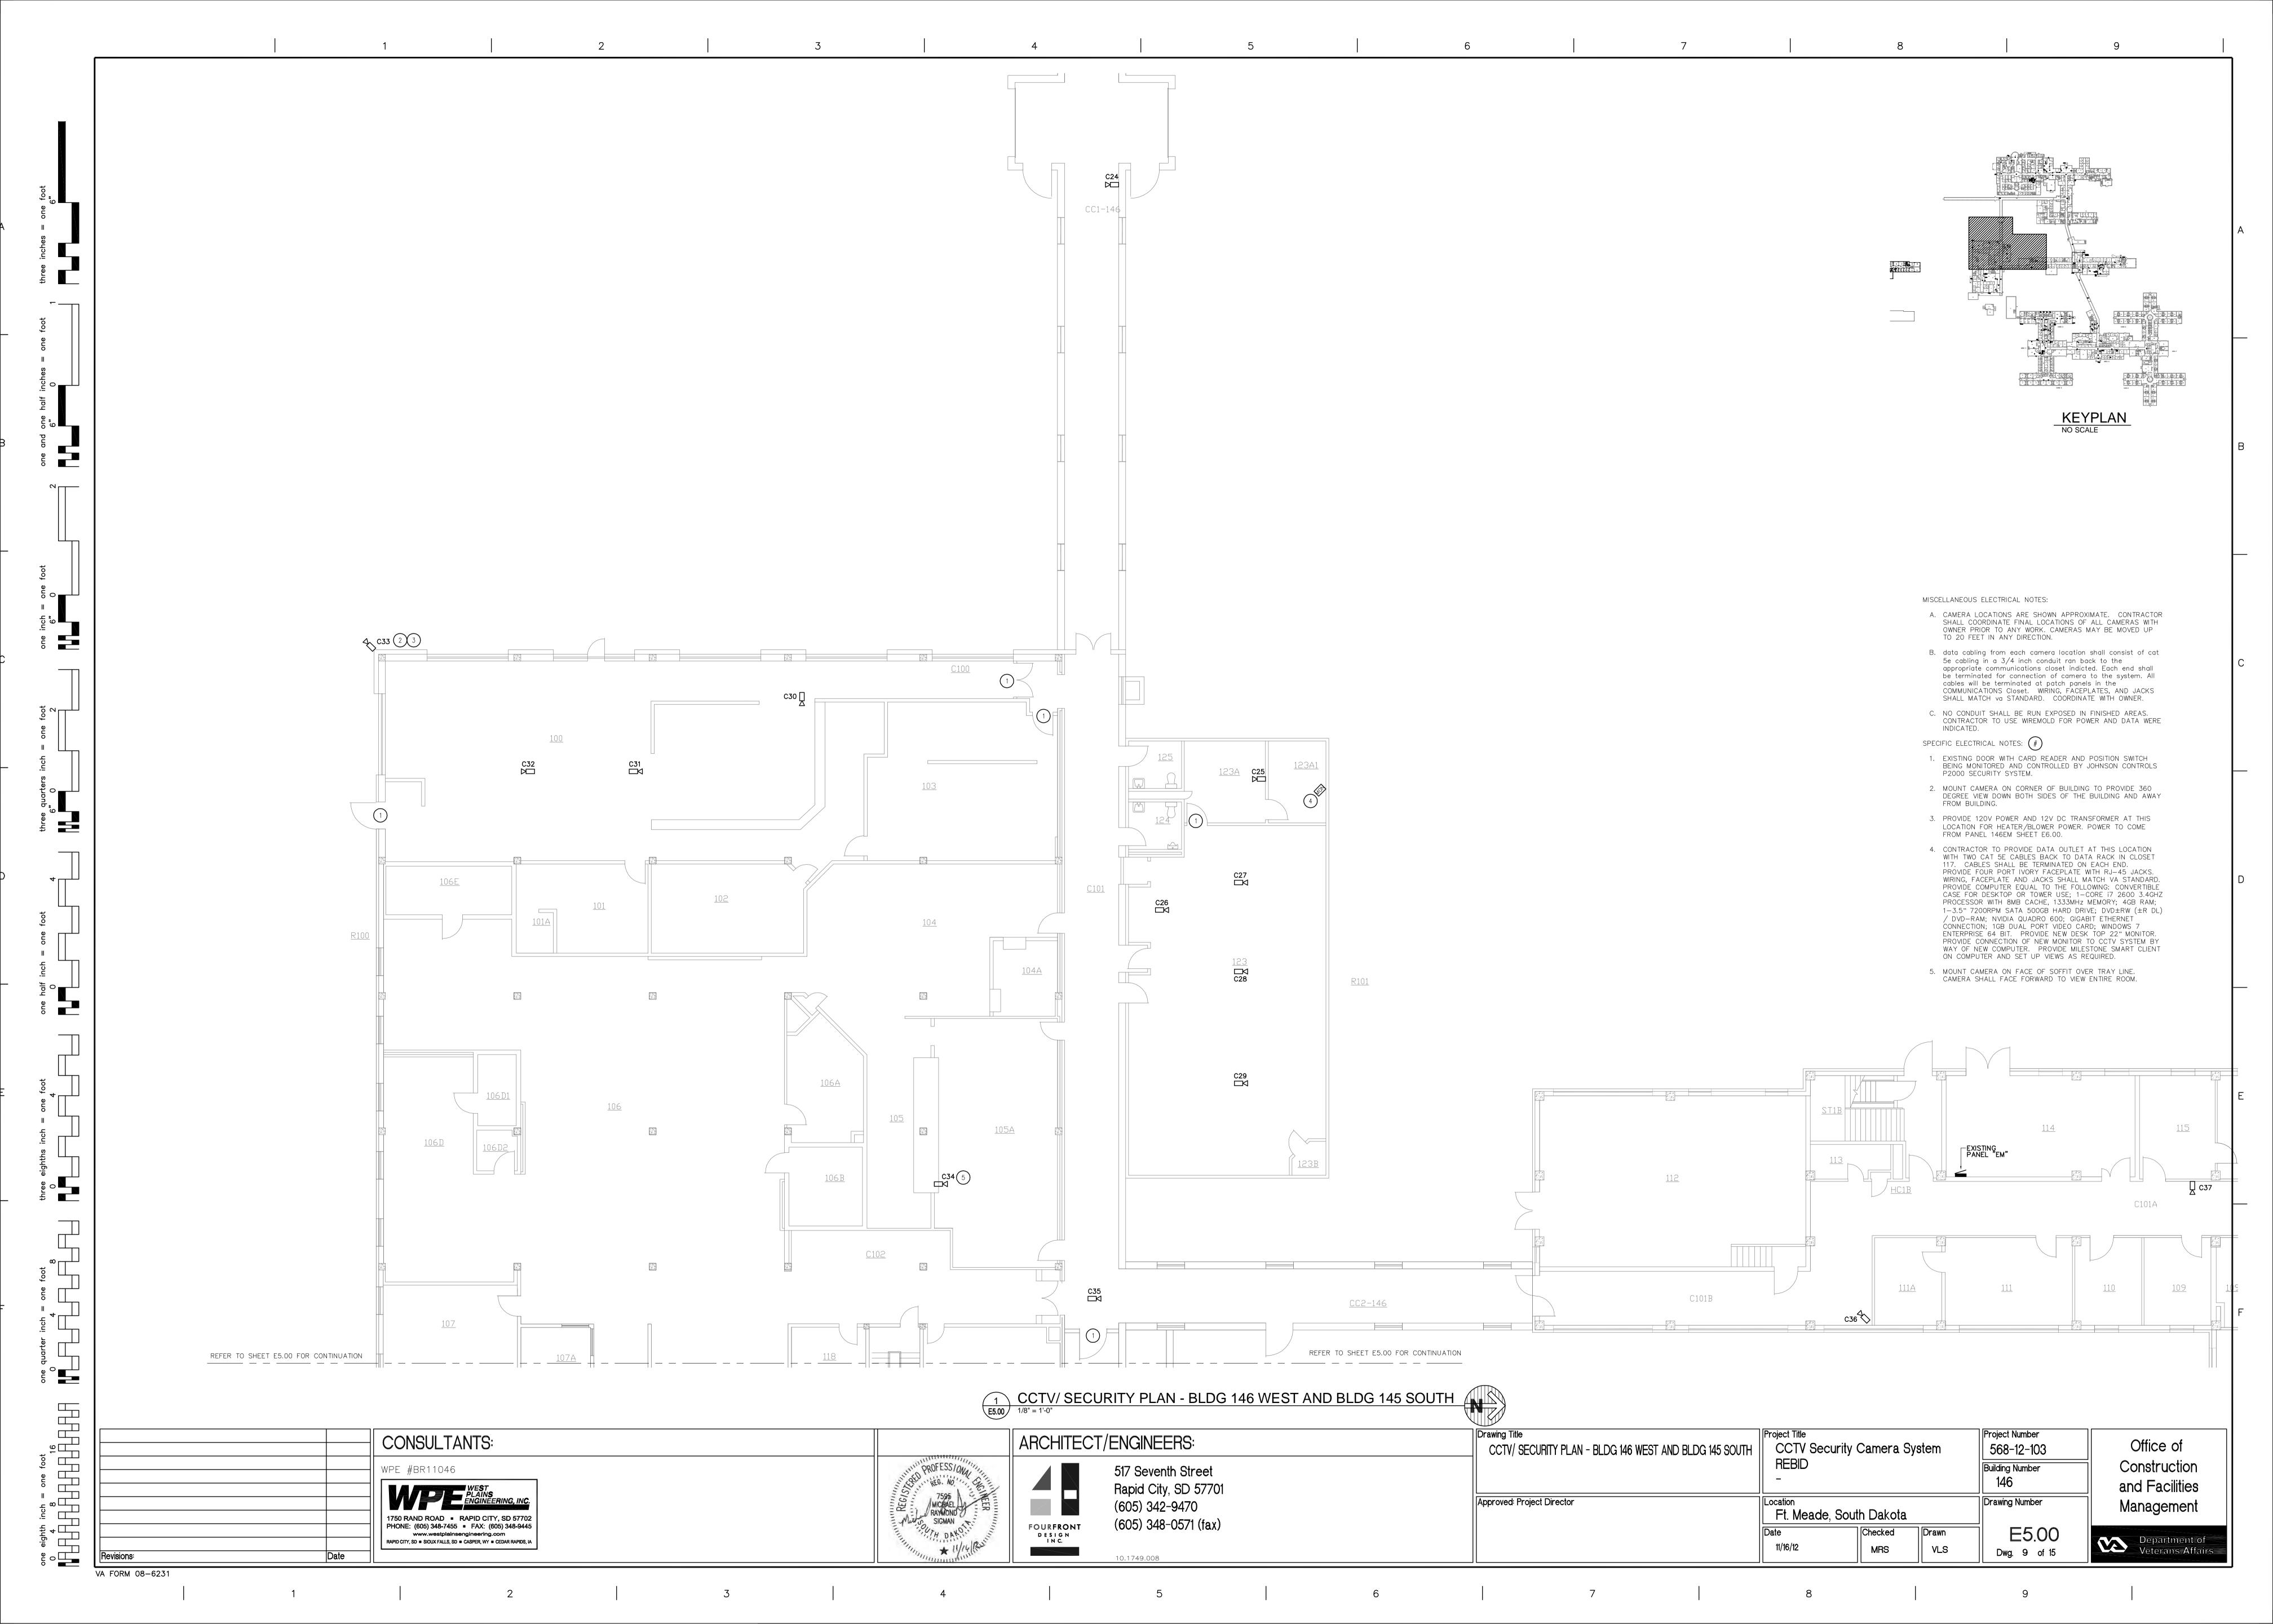

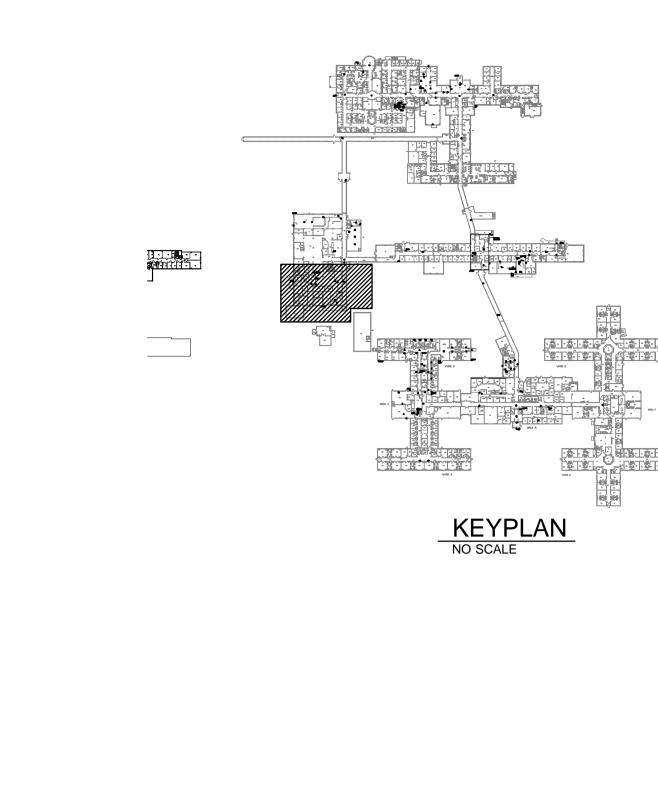



MISCELLANEOUS ELECTRICAL NOTES:

- A. CAMERA LOCATIONS ARE SHOWN APPROXIMATE. CONTRACTOR SHALL COORDINATE FINAL LOCATIONS OF ALL CAMERAS WITH OWNER PRIOR TO ANY WORK. CAMERAS MAY BE MOVED UP TO 20 FEET IN ANY DIRECTION.
- B. DATA CABLING FROM EACH CAMERA LOCATION SHALL
 CONSIST OF CAT 5E CABLING IN A 3/4 INCH CONDUIT RAN
 BACK TO THE APPROPRIATE COMMUNICATIONS CLOSET
 INDICTED. EACH END SHALL BE TERMINATED FOR CONNECTION
 OF CAMERA TO THE SYSTEM. ALL CABLES WILL BE
 TERMINATED AT PATCH PANELS IN THE COMMUNICATIONS
 CLOSET. WIRING, FACEPLATES, AND JACKS SHALL MATCH VA
- C. NO CONDUIT SHALL BE RUN EXPOSED IN FINISHED AREAS. CONTRACTOR TO USE WIREMOLD FOR POWER AND DATA WERE INDICATED.

SPECIFIC ELECTRICAL NOTES:

- EXISTING DOOR WITH CARD READER AND POSITION SWITCH BEING MONITORED AND CONTROLLED BY JOHNSON CONTROLS P2000 SECURITY SYSTEM.
- 2. MOUNT CAMERA TO FACE OF BUILDING.

STANDARD. COORDINATE WITH OWNER.

- PROVIDE 120V POWER AND 12V DC TRANSFORMER AT THIS LOCATION FOR HEATER/BLOWER POWER. POWER TO COME FROM PANEL 146EM.
- 4. ALL CAT 5E CABLE FOR CAMERAS SHOWN ON SHEETS E5.00 AND E6.00 TO BE RUN BACK TO THIS CLOSET. CONTRACTOR
- AND E6.00 TO BE RUN BACK TO THIS CLOSET. CONTRACTOR TO PROVIDE A NEW CISCO CATALYST 3750 48 PORT VERSION 2 POE SWITCH IN EXISTING COMMUNICATIONS RACK. PROVIDE POWER FROM PANEL 146EM. CONTRACTOR MAY USE EXISTING 20A/1P BREAKER IN SPACE 2 FOR POWER FOR HEATER/BLOWER TRANSFORMERS.

9



2 4 4

o dana


one eighth inch = one foot

0 4 8 16 Drawing Title

CCTV/ SECURITY PLAN - BLDG 146 EAST Project Title
CCTV Security Camera System Project Number CONSULTANTS: ARCHITECT/ENGINEERS: Office of 568-12-103 **REBID** Construction Building Number WPE #BR11046 517 Seventh Street 146 and Facilities Rapid City, SD 57701 7595 MICHAEL RAYMOND SIGMAN SIGMAN Approved: Project Director Drawing Number (605) 342-9470 Management Ft. Meade, South Dakota 1750 RAND ROAD • RAPID CITY, SD 57702 PHONE: (605) 348-7455 • FAX: (605) 348-9445 (605) 348-0571 (fax) FOURFRONT DESIGN INC. E6.00 www.westplainsengineering.com

RAPID CITY, SD = SIOUX FALLS, SD = CASPER, WY = CEDAR RAPIDS, IA Department of Veterans Affairs 11/16/12 MRS VLS Dwg. 10 of 15 10.1749.008 Revisions: VA FORM 08-6231

6 | 7 |

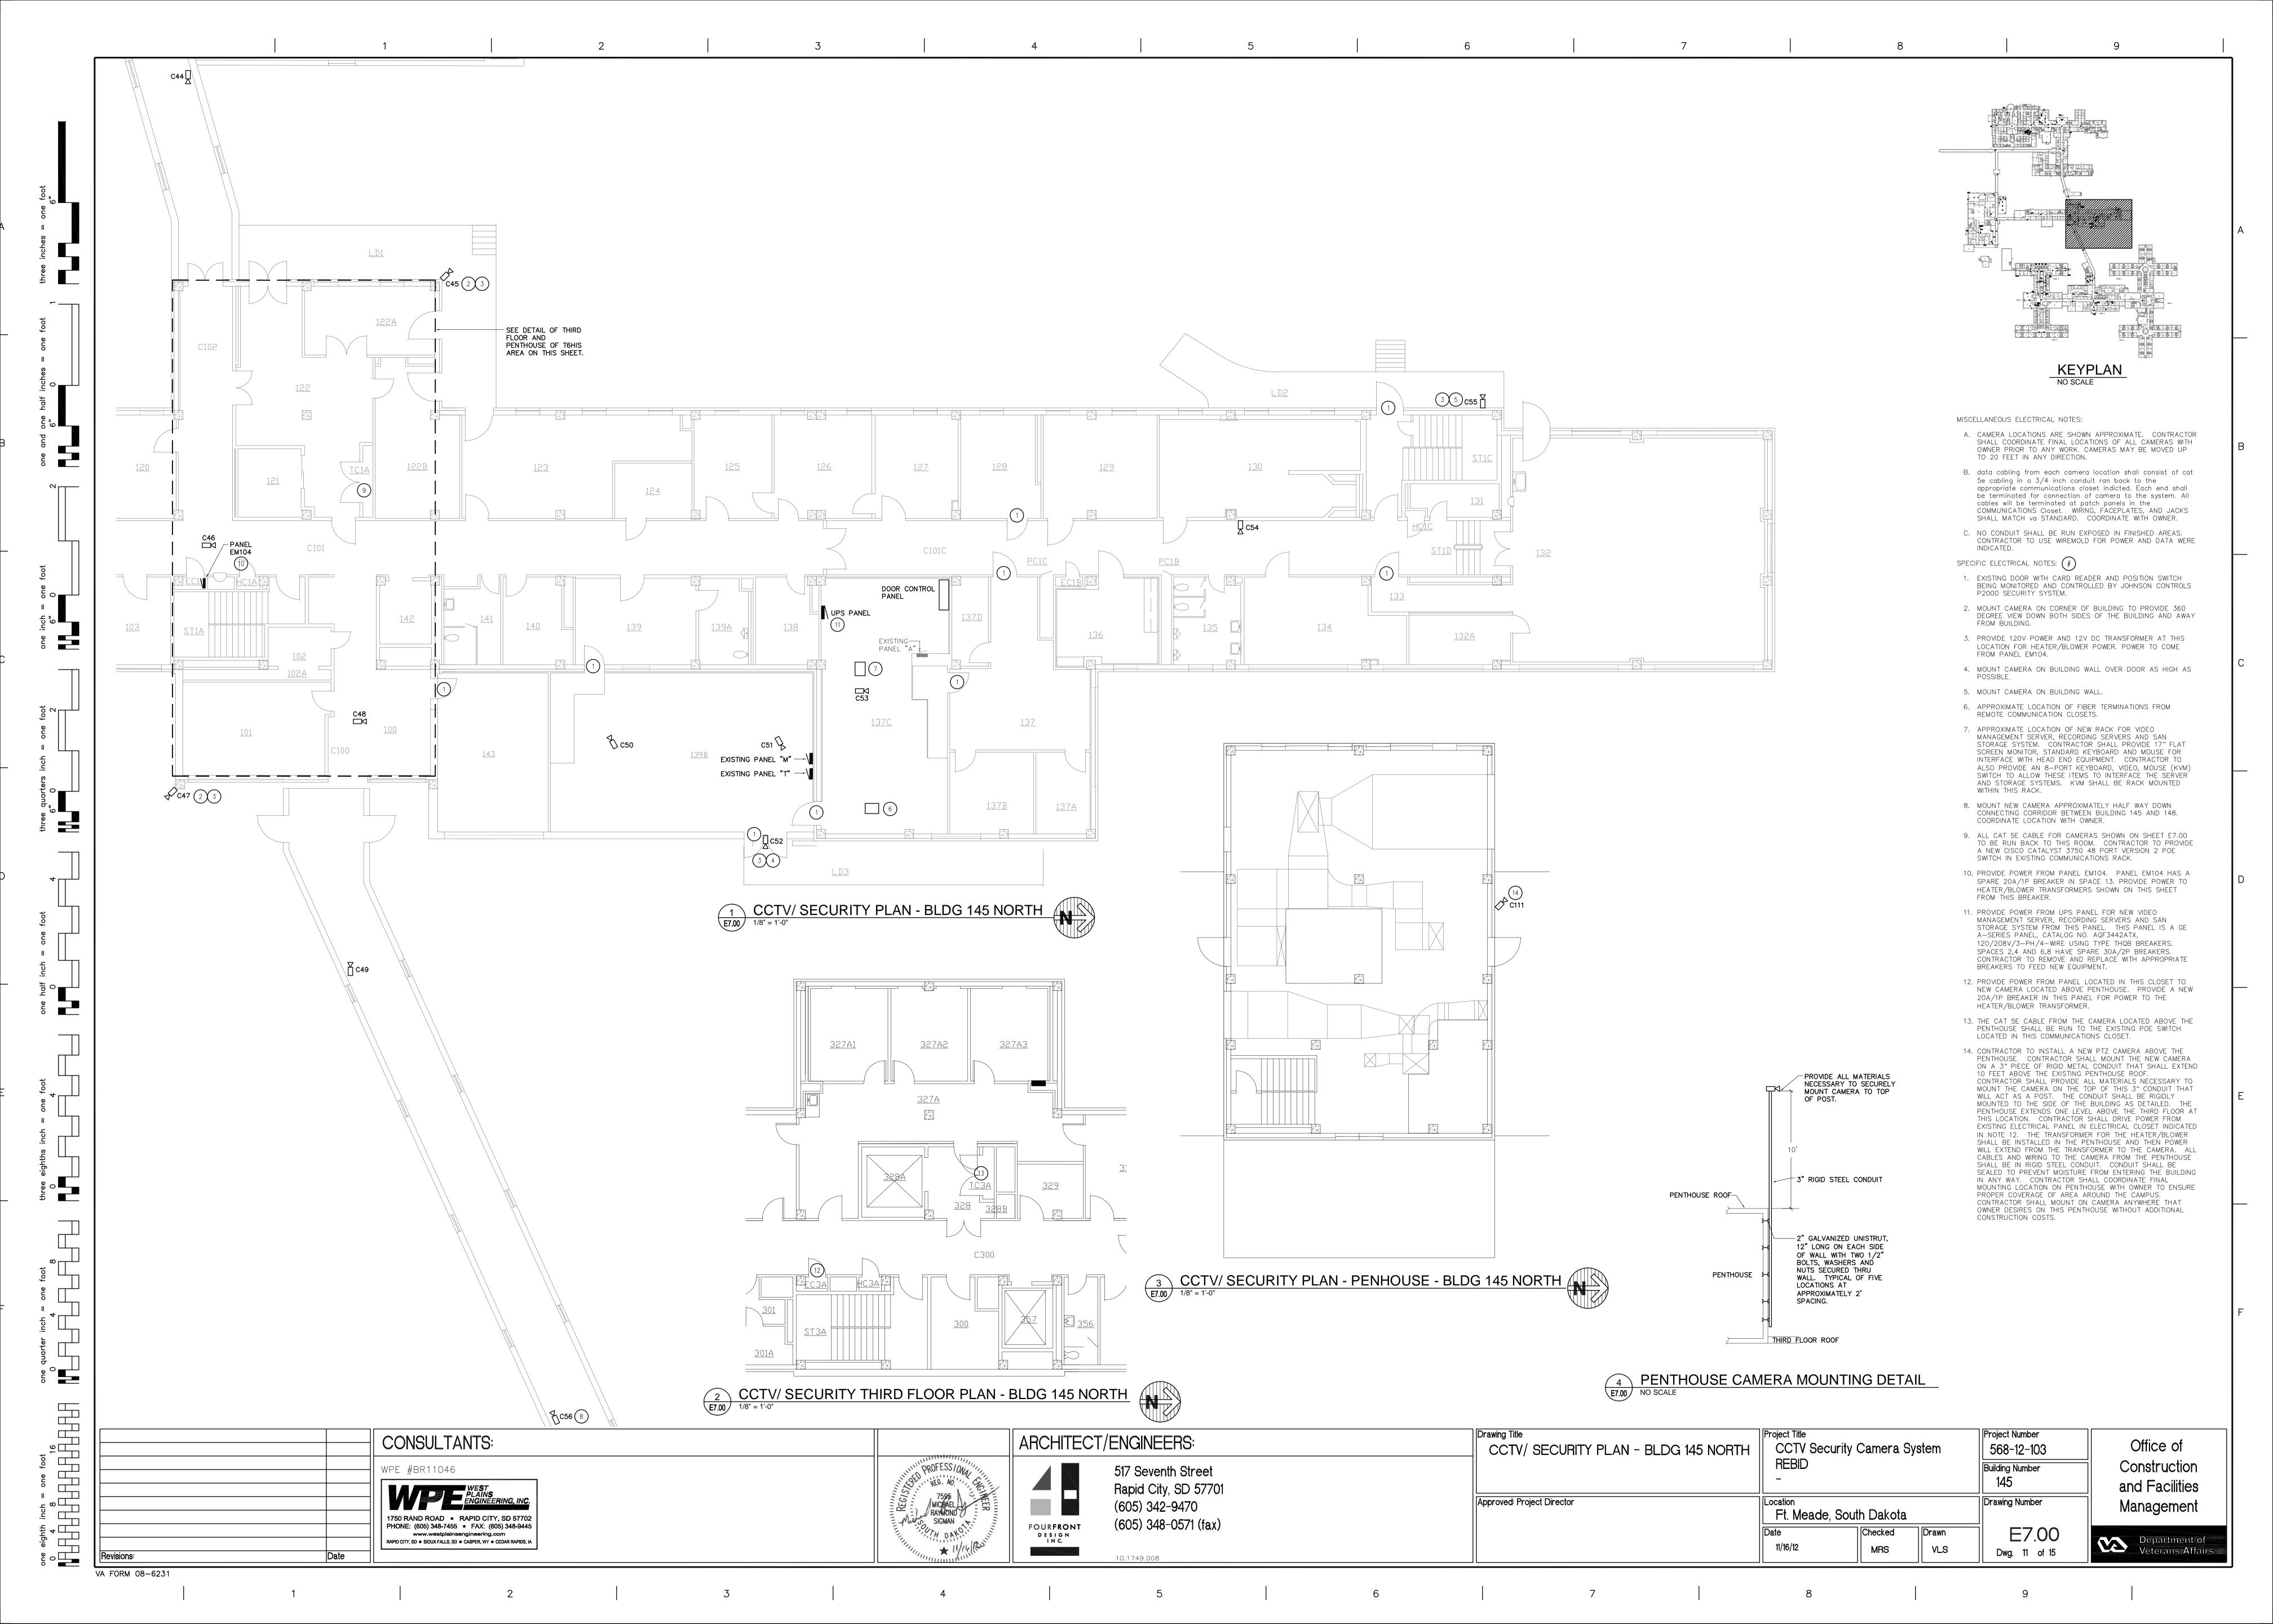

MISCELLANEOUS ELECTRICAL NOTES: <u>D119</u> A. CAMERA LOCATIONS ARE SHOWN APPROXIMATE. CONTRACTOR SHALL COORDINATE FINAL LOCATIONS OF ALL CAMERAS WITH OWNER PRIOR TO ANY WORK. CAMERAS MAY BE MOVED UP D131/132 TO 20 FEET IN ANY DIRECTION. B. data cabling from each camera location shall consist of cat 5e cabling in a 3/4 inch conduit ran back to the appropriate communications closet indicted. Each end shall cables will be terminated at patch panels in the COMMUNICATIONS Closet. WIRING, FACEPLATES, AND JACKS SHALL MATCH va STANDARD. COORDINATE WITH OWNER. C. NO CONDUIT SHALL BE RUN EXPOSED IN FINISHED AREAS.

CONTRACTOR TO USE WIREMOLD FOR POWER AND DATA WERE 5 MON MON (4) SPECIFIC ELECTRICAL NOTES: (#) 1. EXISTING DOOR WITH CARD READER AND POSITION SWITCH BEING MONITORED AND CONTROLLED BY JOHNSON CONTROLS P2000 SECURITY SYSTEM. 2. MOUNT CAMERA ON BUILDING WALL. <u>D118</u> <u>D116</u> <u>D112</u> <u>D114</u> <u>D110</u> 3. PROVIDE 120V POWER AND 12V DC TRANSFORMER AT THIS LOCATION FOR HEATER/BLOWER POWER. <u>D109</u> 4. CONTRACTOR TO PROVIDE DATA OUTLET AT THIS LOCATION WITH TWO CAT 5E CABLES BACK TO DATA RACK IN CLOSET CEC1. CABLES SHALL BE TERMINATED ON EACH END. PROVIDE FOUR PORT IVORY FACEPLATE WITH RJ-45 JACKS. C63 2 3 7 WIRING, FACEPLATE AND JACKS SHALL MATCH VA STANDARD. PROVIDE COMPUTER EQUAL TO THE FOLLOWING: CONVERTIBLE CASE FOR DESKTOP OR TOWER USE; 1-CORE i7 2600 3.4GHZ PROCESSOR WITH 8MB CACHE, 1333MHz MEMORY; 4GB RAM; 1-3.5" 7200RPM SATA 500GB HARD DRIVE; DVD \pm RW (\pm R DL) / DVD-RAM; NVIDIA QUADRO 600; GIGABIT ETHERNET CONNECTION; 1GB DUAL PORT VIDEO CARD; WINDOWS 7 ENTERPRISE 64 BIT. PROVIDE NEW DESK TOP 22" MONITOR. PROVIDE CONNECTION OF NEW MONITOR TO CCTV SYSTEM BY WAY OF NEW COMPUTER. PROVIDE MILESTONE SMART CLIENT ON COMPUTER AND SET UP VIEWS AS REQUIRED. CAMERAS C57, C58, C59 AND C60 NEED TO BE VIEWED AT THIS LOCATION. 5. CONTRACTOR TO PROVIDE DATA OUTLET AT THIS LOCATION WITH TWO CAT 5E CABLES BACK TO DATA RACK IN CLOSET CEC1. CABLES SHALL BE TERMINATED ON EACH END. PROVIDE FOUR PORT IVORY FACEPLATE WITH RJ-45 JACKS. WIRING, FACEPLATE AND JACKS SHALL MATCH VA STANDARD. PROVIDE COMPUTER EQUAL TO THE FOLLOWING: CONVERTIBLE CASE FOR DESKTOP OR TOWER USE; 1-CORE i7 2600 3.4GHZ PROCESSOR WITH 8MB CACHE, 1333MHz MEMORY; 4GB RAM; <u>D105</u> 1-3.5" 7200RPM SATA 500GB HARD DRIVE; DVD±RW (±R DL) / DVD-RAM; NVIDIA QUADRO 600; GIGABIT ETHERNET CONNECTION; 1GB DUAL PORT VIDEO CARD; WINDOWS 7 ENTERPRISE 64 BIT. PROVIDE NEW DESK TOP 32" MONITOR. PROVIDE CONNECTION OF NEW MONITOR TO CCTV SYSTEM BY <u>D106</u> WAY OF NEW COMPUTER. PROVIDE MILESTONE SMART CLIENT ON COMPUTER AND SET UP VIEWS AS REQUIRED. 6. PROVIDE NEW 26" MONITOR WITH WALL MOUNTING BRACKET. PROVIDE FOR CONNECTION OF NEW MONITOR TO CCTV SYSTEM <u>D104</u> BY WAY OF NEW COMPUTER OUTLINED IN SPECIFIC NOTE 5 7. MOUNT CAMERA ON BUILDING WALL. 8. PROVIDE POWER FROM PANEL LX-2. THIS PANEL IS A SQUARE D SERIES E2 PANEL, CATALOG NO. NQOD442L225CU, 120/208V/3-PH/4-WIRE USING 10KAIC BREAKERS. CONTRACTOR TO PROVIDE NEW 20A/1P BREAKER IN SPACE 33. PROVIDE POWER TO HEATER/BLOWER TRANSFORMERS SHOWN ON THIS SHEET AND SHEET E9.00 FROM THIS BREAKER. REFER TO SHEET E8.00 FOR CONTINUATION REFER TO SHEET E8.00 FOR CONTINUATION CCTV/ SECURITY PLAN - BLDG 148 SOUTHWEST , one eighth inch = one foot

4 8 16

16 Project Title
CCTV Security Camera System Project Number CONSULTANTS: ARCHITECT/ENGINEERS: Office of CCTV/ SECURITY PLAN - BLDG 148 SOUTHWEST 568-12-103 **REBID** Construction Building Number WPE #BR11046 517 Seventh Street 148 and Facilities Rapid City, SD 57701 7595 MICHAEL RAYMOND SIGMAN SIGMAN Approved: Project Director Drawing Number (605) 342-9470 Management Ft. Meade, South Dakota 1750 RAND ROAD • RAPID CITY, SD 57702 PHONE: (605) 348-7455 • FAX: (605) 348-9445 (605) 348-0571 (fax) FOURFRONT DESIGN INC. E8.00 www.westplainsengineering.com


RAPID CITY, SD = SIOUX FALLS, SD = CASPER, WY = CEDAR RAPIDS, IA Department of Veterans Affairs 11/16/12 MRS Dwg. 12 of 15 10.1749.008


6 7


9

3 4

VA FORM 08-6231

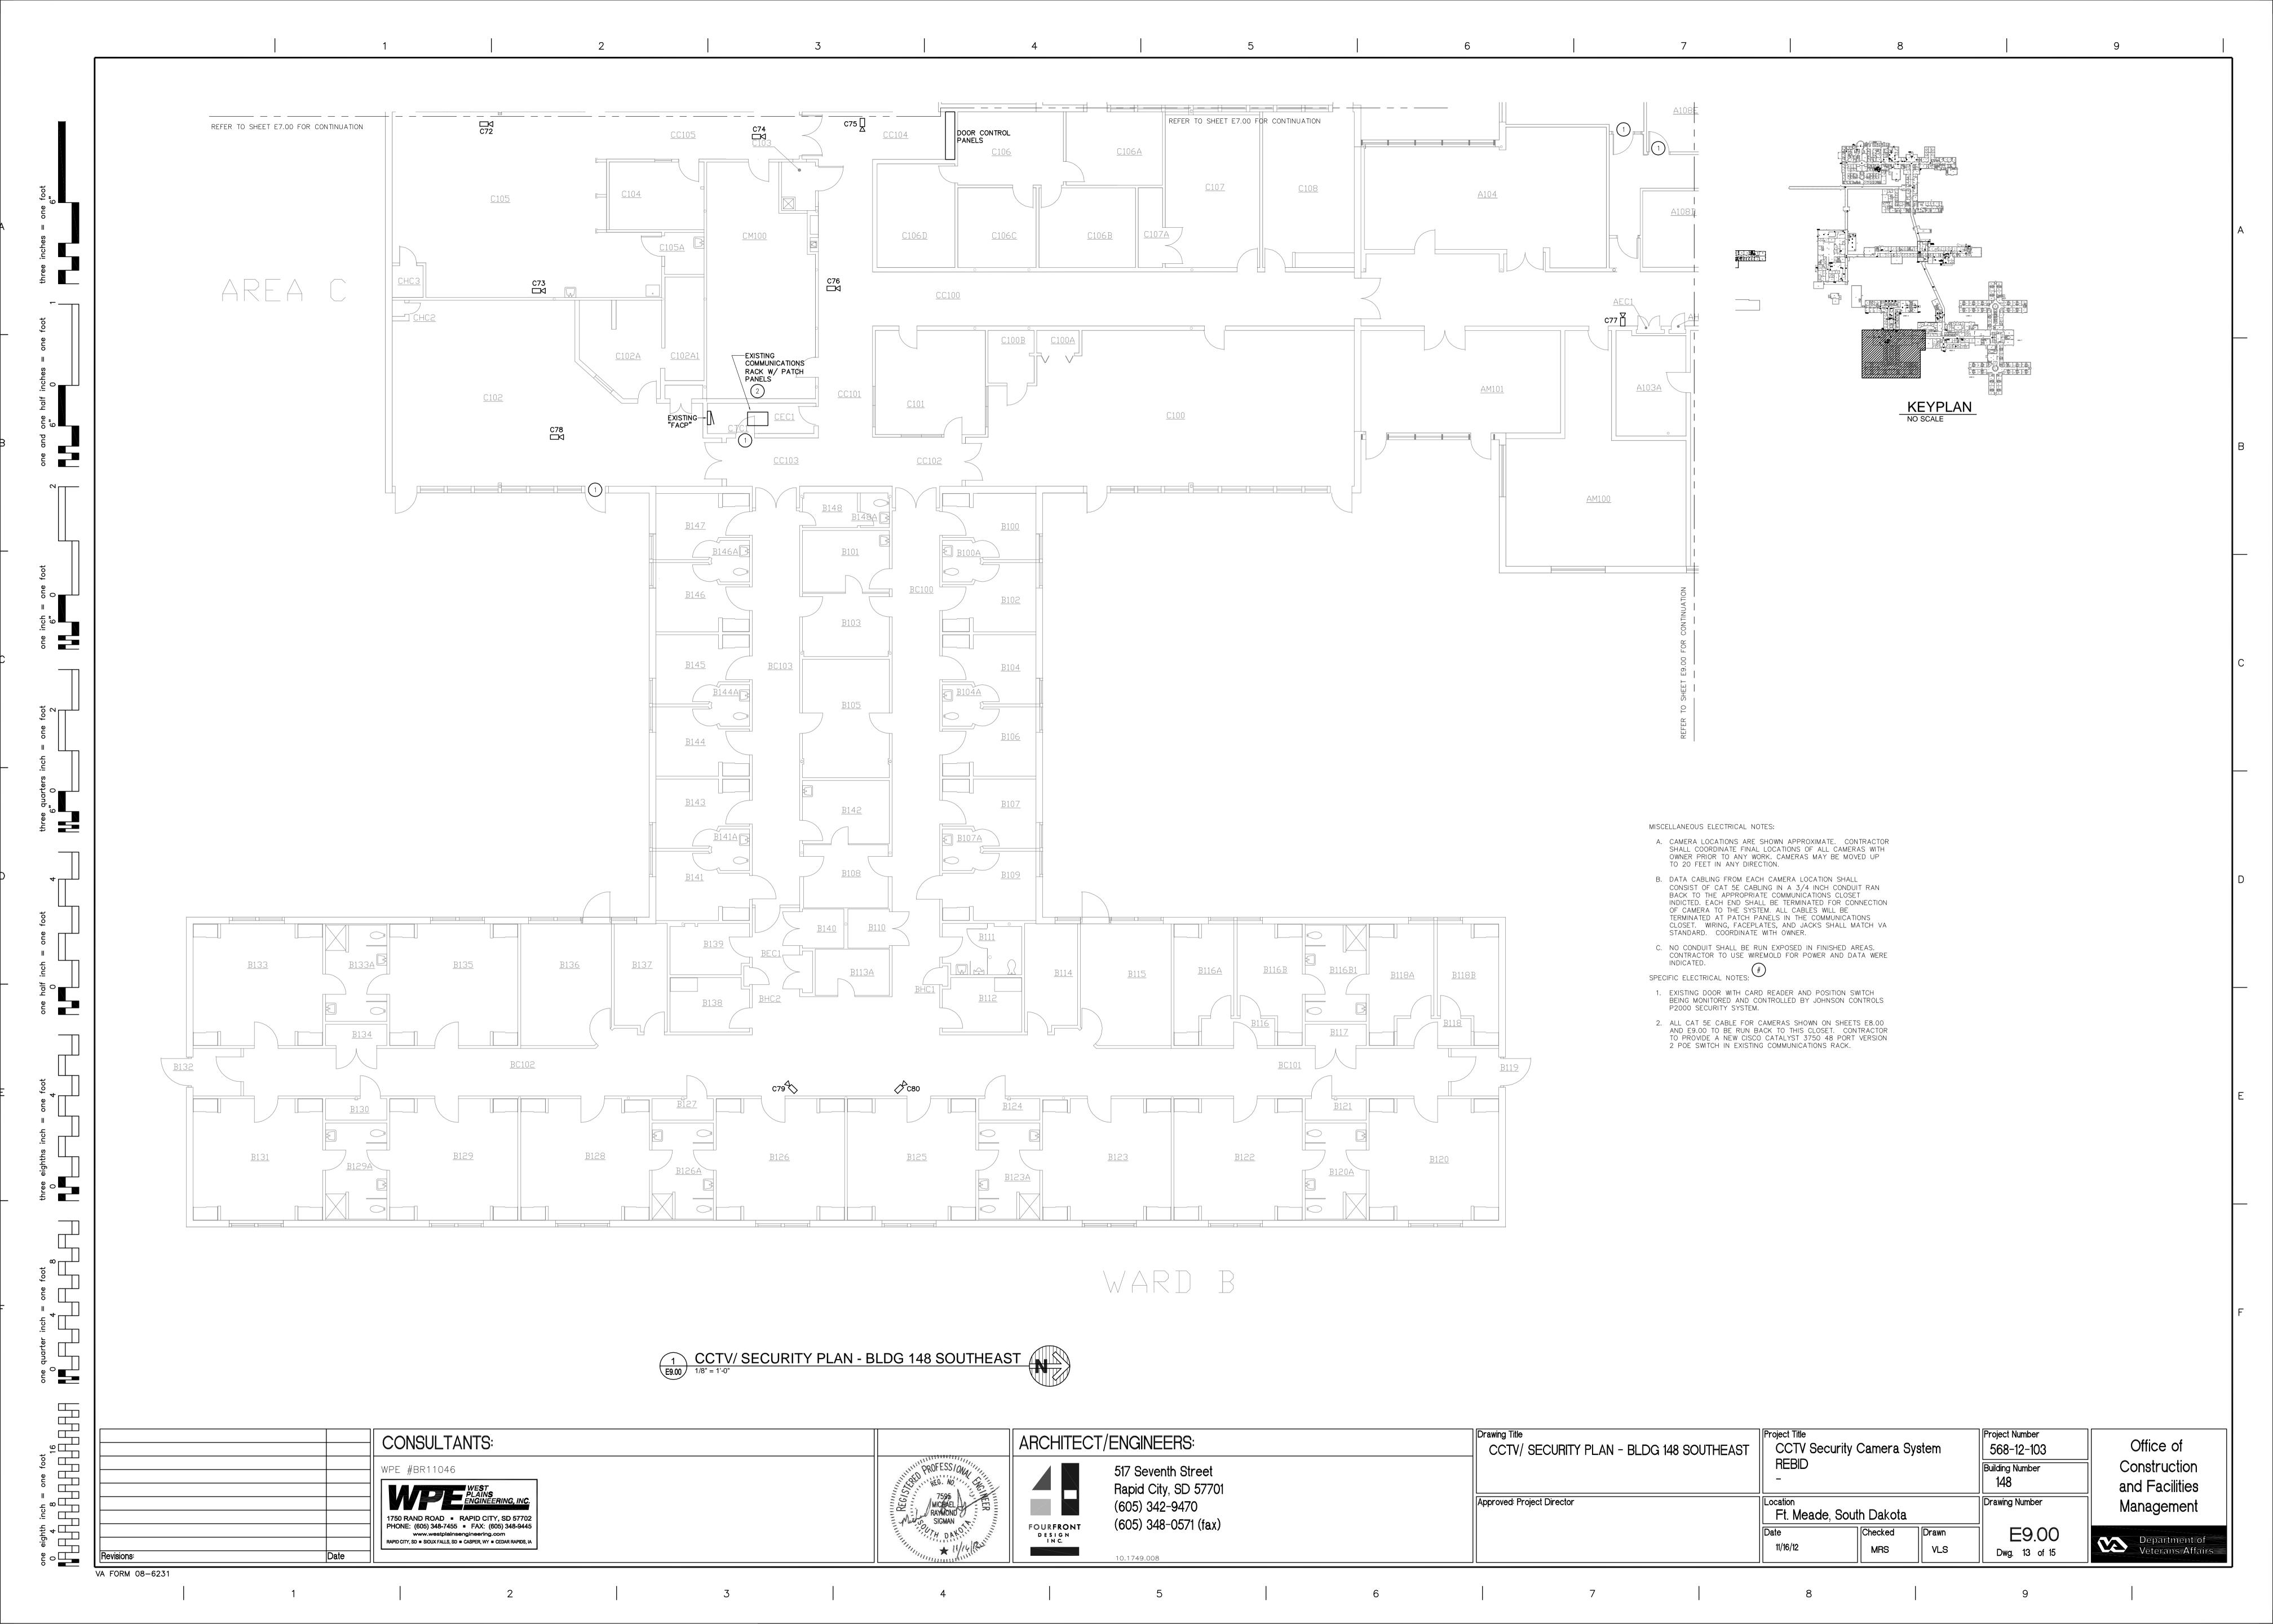

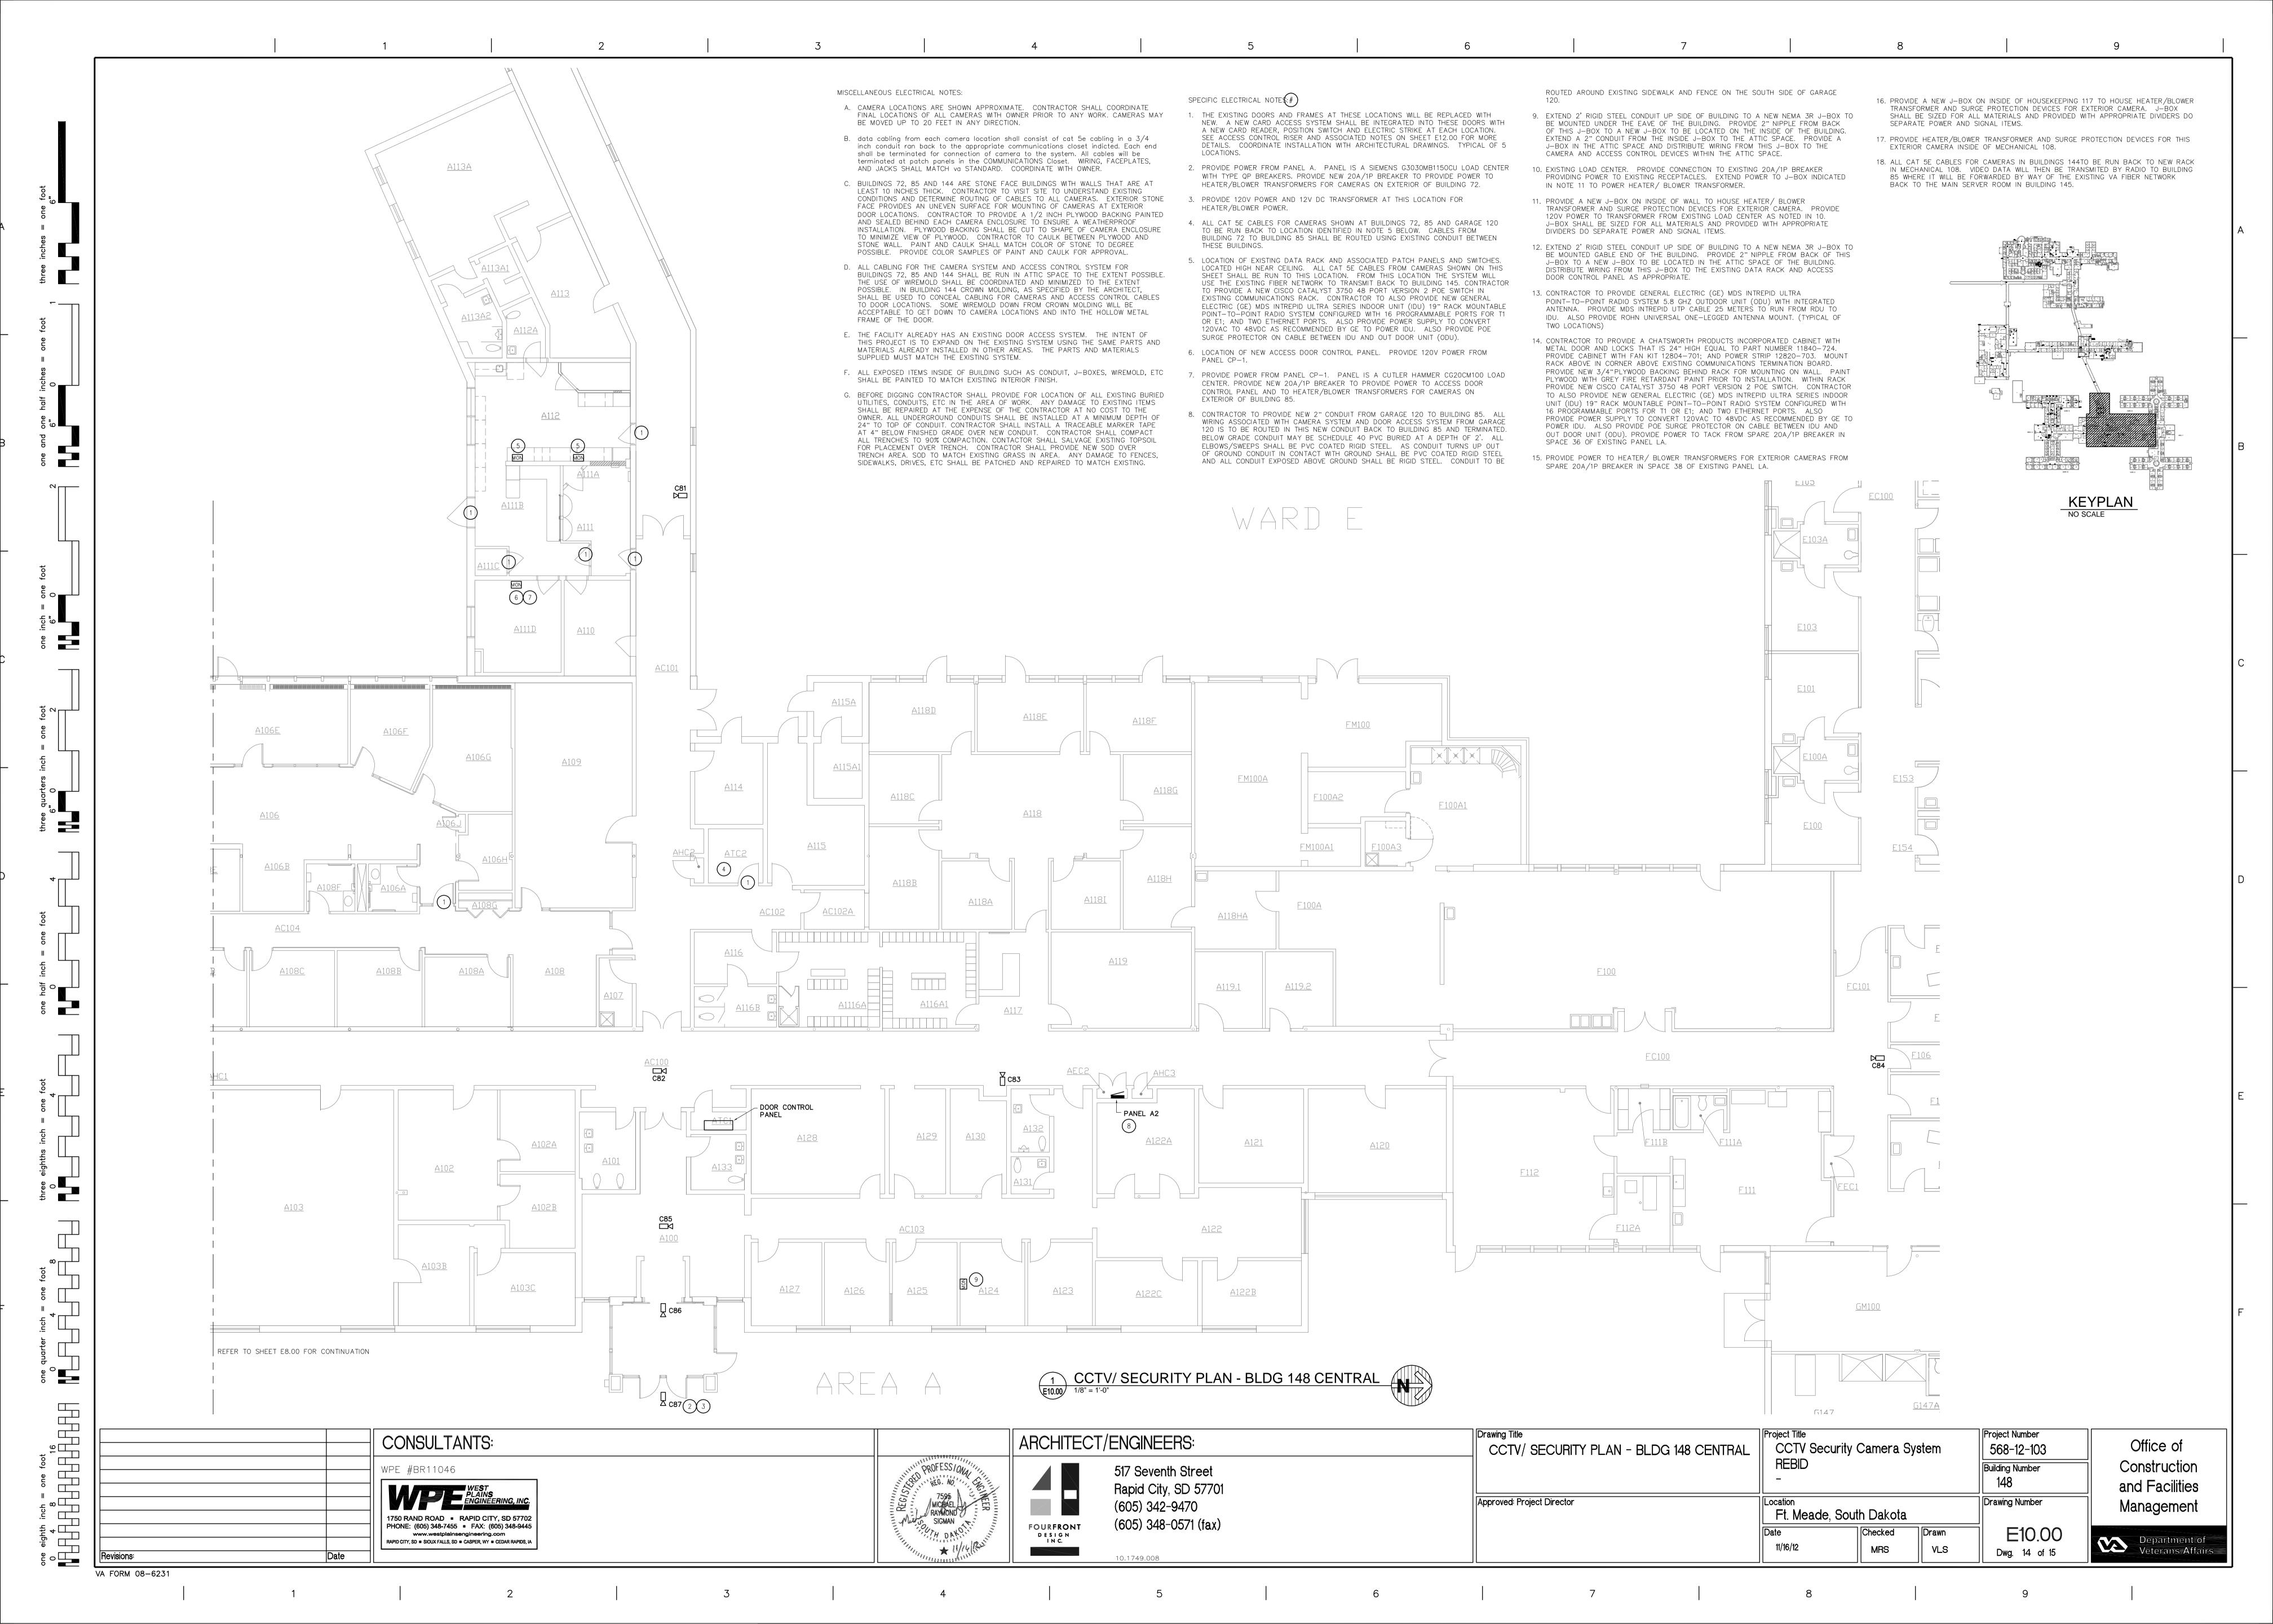

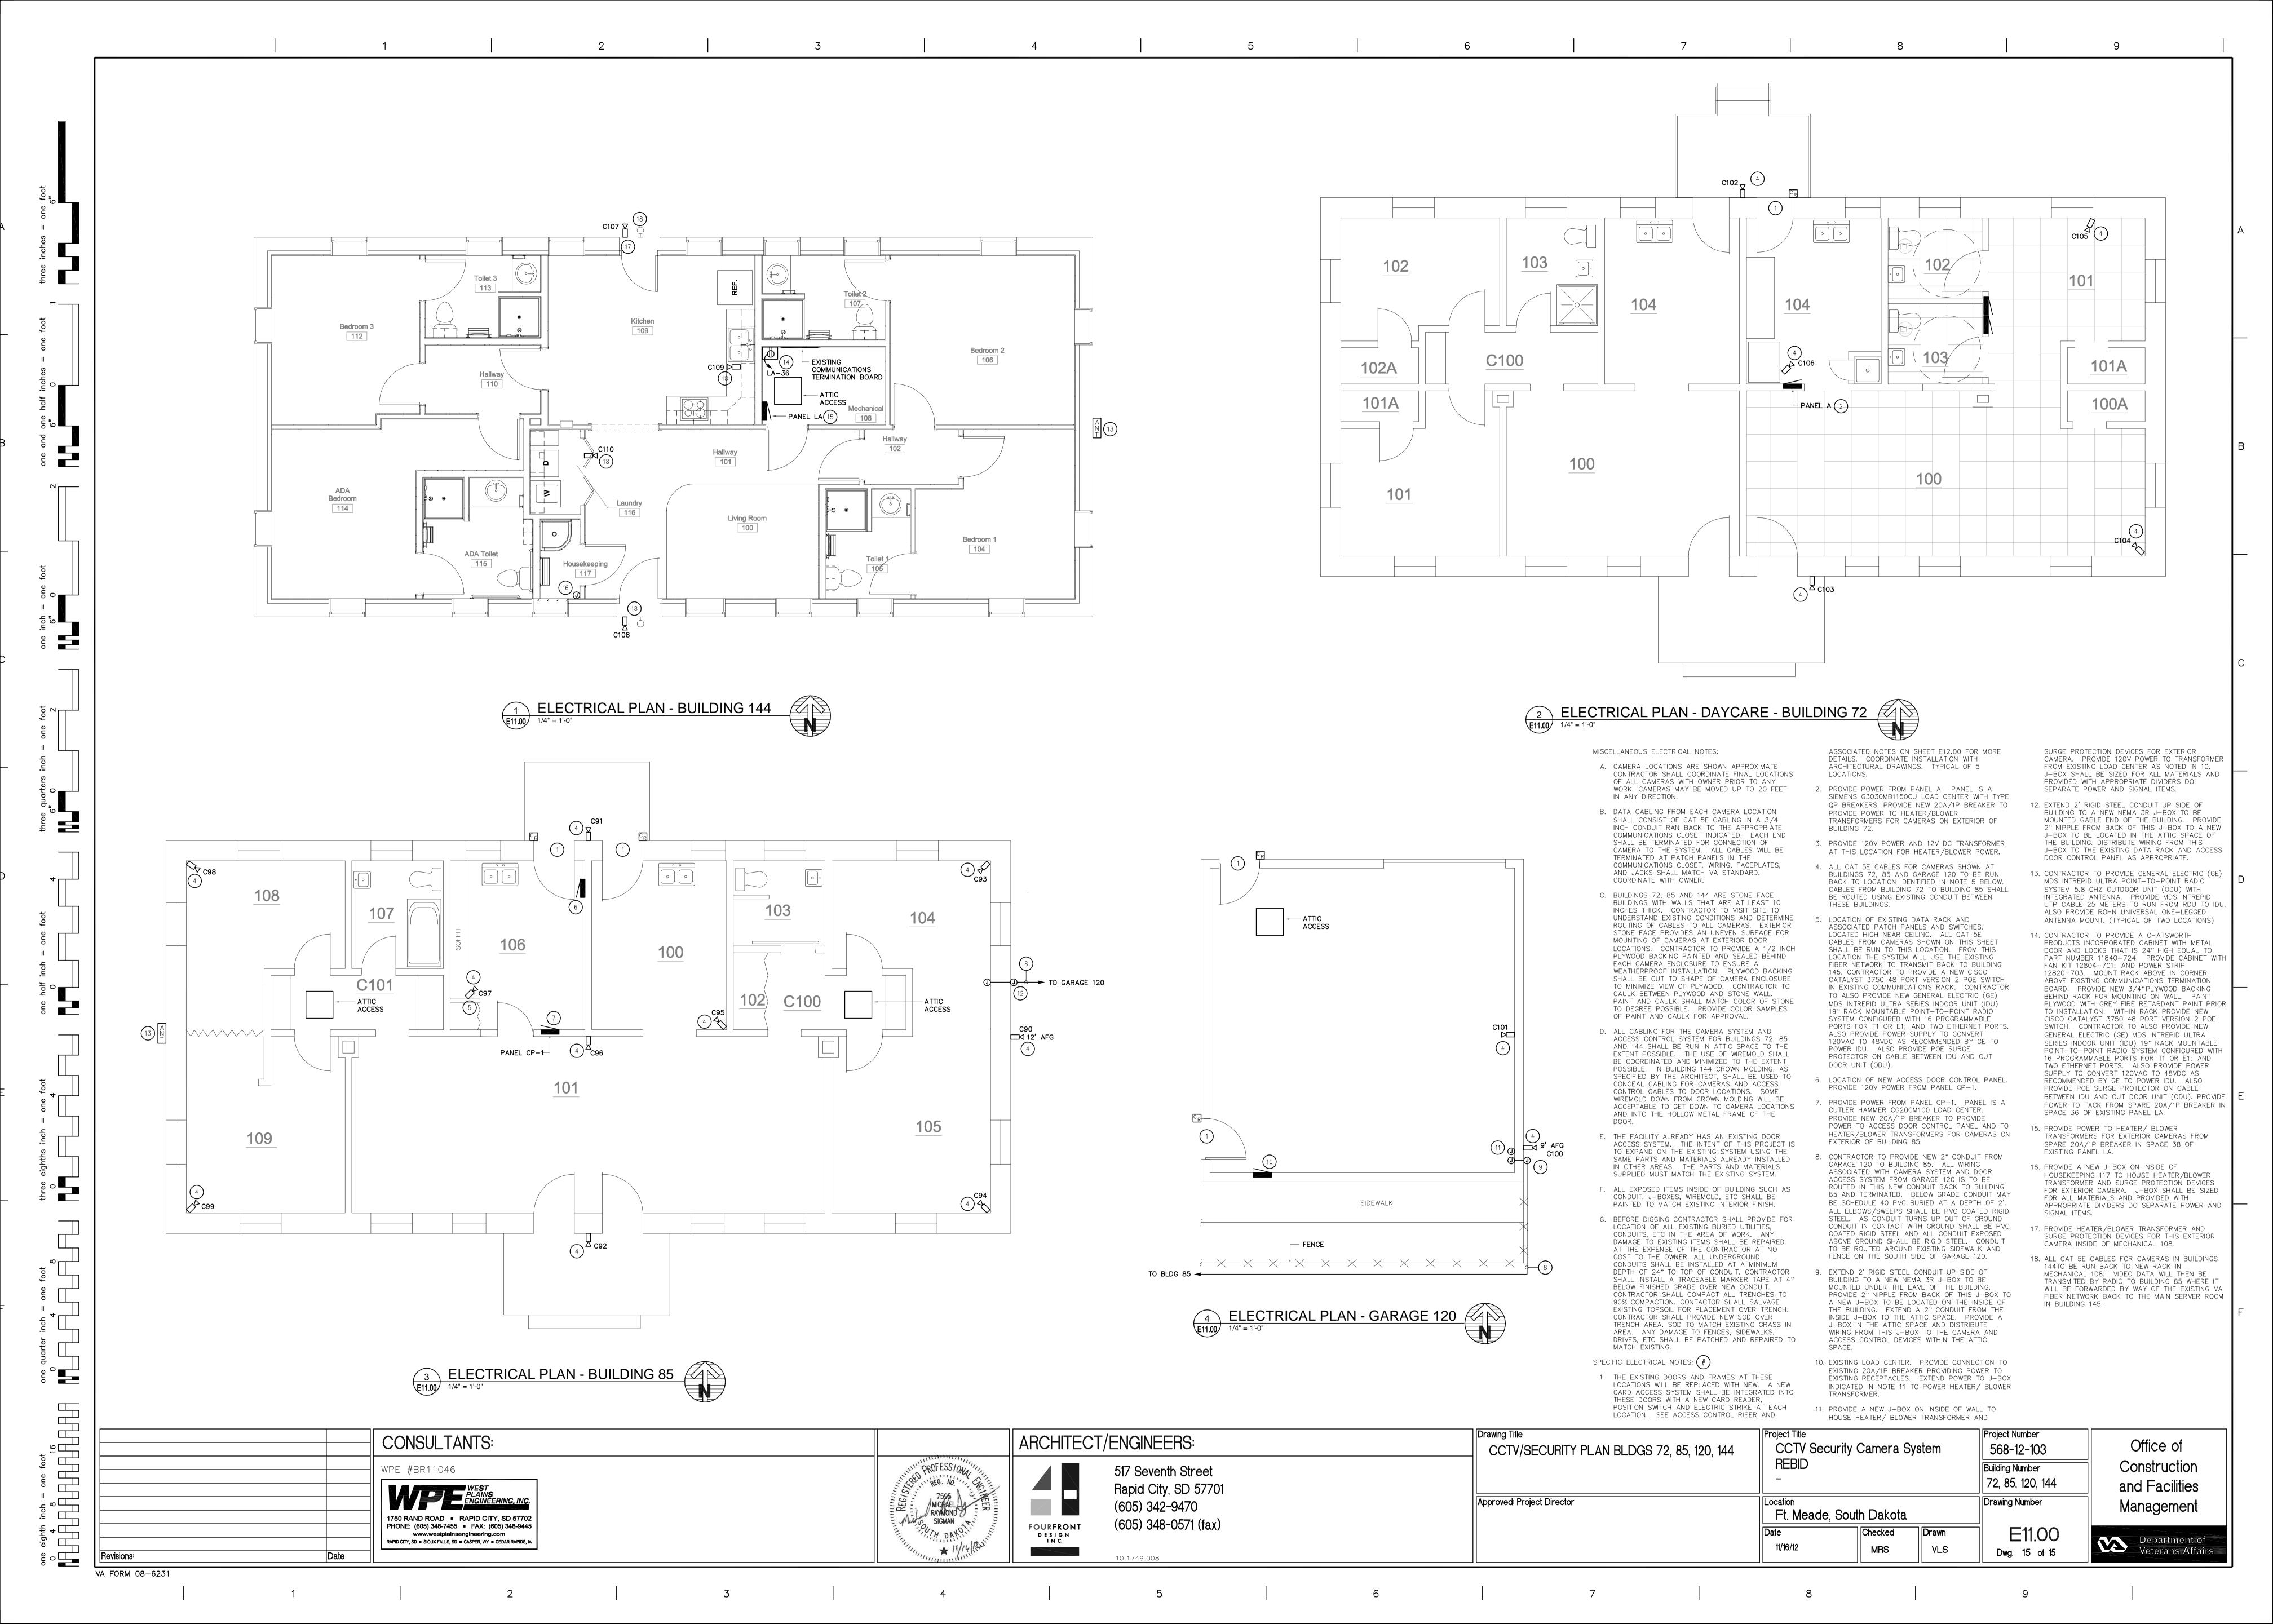



MISCELLANEOUS ELECTRICAL NOTES:

A. THE FACILITY ALREADY HAS AN EXISTING DOOR ACCESS SYSTEM. THE INTENT OF THIS PROJECT IS TO EXPAND ON THE EXISTING SYSTEM USING THE SAME PARTS AND MATERIALS ALREADY INSTALLED IN OTHER AREAS. THE PARTS AND MATERIALS SUPPLIED MUST MATCH THE EXISTING

B. CONTRACTOR TO PROVIDE ALL INTERCONNECTING WIRING PER MANUFACTURER REQUIREMENTS TO MAKE A COMPLETE AND WORKING SYSTEM TO MATCH THE FORM AND FUNCTION OF THE EXISTING


specific electrical notes: #

 CONTRACTOR TO PROVIDE NEW DOOR CONTROL PANEL CONSISTING OF THE FOLLOWING: DATA NETWORK CONTROLLER TO BE JOHNSON CONTROLS MODEL CK721—A; THREE 2—DOOR CONTROLLER MODULES TO BE JOHNSON CONTROLS MODEL S300-DIN-RDR2SA; 24 VOLT LOCK POWER SUPPLY TO BE ALTRONIX MODEL SMP-10PM; LOCK POWER TRANSFORMER TO BE ALTRONIX MODEL T2428300; 12 VOLT CARD READER POWER SUPPLY TO BE ALTRONIX MODEL SMP-7PM; CARD READER TRANSFORMER TO BE ALTRONIX MODEL T2428175; LOCK RELAY BOARD TO BE BASE ELECTRONICS MODEL LV-8RS-N; 12V BATTERY BACK UP TO BE ADI ULTRATECH MODEL 12180; ENCLOSURE STATUS CONTACT EQUAL TO GENERAL ELECTRIC SENTROL MODEL 1032;END OF LINE RESISTOR PACKS EQUAL TO GRI MODEL 6644T; AND CONTROLLER

2. EACH DOOR LOCATION NOTED TO RECEIVE THE FOLLOWING: ONE ICLASS MULLION MOUNTED (DOOR FRAME) PROXIMITY CARD READER TO BE AN HID MODEL R10: ONE ELECTRIC STRIKE TO BE VON DUPRIN MODEL 6211; ONE DOOR STATUS CONTACT TO BE GENERAL ELECTRIC MODEL 2505A-L; AND END OF LINE RESISTOR PACKS EQUAL TO GRI MODEL 6644T. CONTRACTOR TO PROVIDE ALL CABLES NECESSARY TO INTERCONNECT AND TIE TO NEW CONTROL PANEL TO MAKE A COMPLETE AND WORKABLE SYSTEM MATCHING THE FUNCTION OF THE EXISTING SYSTEM.

3. CONTRACTOR SHALL PROVIDE ALL PROGRAMMING NECESSARY OF THE JOHNSON CONTROLS J2000 SECURITY SYSTEM TO INTEGRATE AND MONITOR THESE NEW COMPONENTS TO THE EXISTING SECURITY ACCESS AND MONITORING SYSTEM.

4. CONTRACTOR TO PROVIDE NEW 2" CONDUIT FROM GARAGE 120 TO BUILDING 85. ALL WIRING ASSOCIATED WITH CAMERA SYSTEM AND DOOR ACCESS SYSTEM FROM GARAGE 120 IS TO BE ROUTED IN THIS NEW CONDUIT BACK TO BUILDING 85 AND TERMINATED.

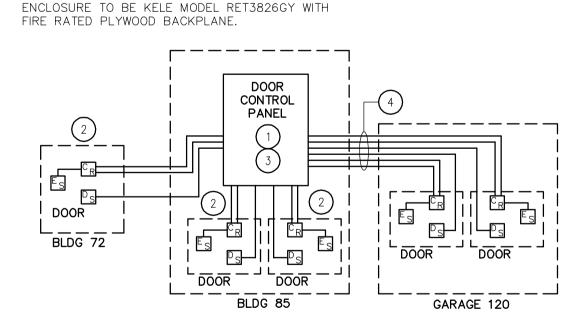

ACCESS CONTROL RISER DIAGRAM

A or AMP	AMPERE	LA	LIGHTNING ARRESTOR
A/C A/E or AE	AIR CONDITIONING ARCHITECT & ENGINEER	LT LTG	LIGHT LIGHTING
ac	ABOVE COUNTER	LTS	LIGHTS
AC ADA	ALTERNATING CURRENT AMERICANS WITH DISABILITIES ACT	MC	MECHANICAL CONTRACTOR
AFF	ABOVE FINISH FLOOR	MCB	MAIN CIRCUIT BREAKER
AFG AFI or AFCI	ABOVE FINISH GRADE ARC FAULT CIRCUIT INTERRUPTER	MCC MCM	MOTOR CONTROL CENTER THOUSAND CIRCULAR MILS
AHJ	AUTHORITY HAVING JURISDICTION	MDP	MAIN DISTRIBUTION PANEL
AHU AIC	AIR HANDLING UNIT AMPERES INTERRUPTING CURRENT	MECH MFS	MECHANICAL MAIN FUSIBLE SWITCH
AL	ALUMINUM	MH	METAL HALIDE
ANN AS	ANNUNCIATOR AUTOMATIC SENSORS	MLO MON	MAIN LUG ONLY MONITOR
AWG	AMERICAN WIRE GAUGE	MSB	MAIN SWITCHBOARD
oc	BELOW COUNTER	MTD MTS	MOUNTED MOTOR THERMAL SWITCH
3C	BELOW COUNTER	MV	MERCURY VAPOR
BH BL	BASKETBALL HOOP OPER BLEACHER ELECTRIC OPERATOR	NA or N/A	NOT APPLICABLE
BRD or BD	BOARD	NC NC	NORMALLY CLOSED
вин	BLAST UNIT HEATER	NEC NEMA	NATIONAL ELECTRICAL CODE
c or COND	CONDUIT		NATIONAL ELECTRICAL MANUFACTURERS ASSOCIATION
C/B or CB	CIRCUIT BREAKER	NEU, NEUT or N	NEUTRAL
CAT CCT or CKT	CATEGORY CIRCUIT	NF NL	NON-FUSED NIGHT LIGHT
ZM	CARBON MONOXIDE SENSOR	NO	NORMALLY OPEN
COMB	CARBON MONOXIDE COMBINATION	OFF, OF, or OFC	OFFICE
CONF	CONFERENCE	OH	OVERHEAD
P PTC	CEILING PROJECTOR CABLE TERMINATION CABINET	OHD	OVERHEAD DOOR
Cu or CU	COPPER	P	POLE
U UH	CONDENSING UNIT CABINET UNIT HEATER	PA PB	PUBLIC ADDRESS PUSH BUTTON
		РН	PHASE
oc oc	DIRECT CURRENT DISTRIBUTION CABINET	PLBG PNL	PLUMBING PANEL
DP	DISTRIBUTION PANEL	PR or pr	PAIR
DISC DISP	DISCONNECT DISPOSAL	PRV PS	POWER ROOF VENTILATOR PULL SWITCH
DL	DOCK LEVELER	PS	PROTECTION SCREEN
ON or DWN OR	DOWN DOOR	PTZ PVC	PAN TILT ZOOM POLYVINYL CHLORIDE
OVR	DIGITAL VIDEO RECORDER	PWR	POWER
DWG	DRAWING	RCP	REFLECTED CEILING PLAN
C	ELECTRICAL CONTRACTOR	REC or RECEPT	RECEPTACLE
C F	ELECTRICAL CABINET EXHAUST FAN	REF or REFRIG RF	REFRIGERATOR RADIO FREQUENCY
ЕН	ELECTRICAL HEAT	RH	RADIANT HEAT
ELEC	ELECTRIC OR ELECTRICAL ELECTRIC HAND DRYER	RH RLY	RANGE HOOD RELAY
EM or EMERG	EMERGENCY	RM	ROOM
EMT ENT	ELECTRICAL METALLIC TUBING ELECTRICAL NON-METALLIC TUBING	RMS SCC	SHORT CIRCUIT CURRENT
EUH	ELECTRIC UNIT HEATER	SD	SMOKE DETECTOR
EWC	ELECTRIC WATER COOLER EXISTING	SFR SFTY	SAFETY RECEPTACLE SAFETY
EXP	EXPLOSION PROOF	SHLD	SHIELD OR SHIELDED
F or FUS	FUSE OR FUSIBLE	SIG SMR	SIGNAL SURFACE MOUNT RACEWAY
FA	FIRE ALARM	SN	SOLID NEUTRAL
FAAP FACP	FIRE ALARM ANNUNCIATOR PANEL FIRE ALARM CONTROL PANEL	SP SPECS	SUMP PUMP SPECIFICATIONS
FBO	FURNISHED BY OTHERS	SPKR	SPEAKER
FL, FLU or FLUOR FLA	FLUORESCENT FULL LOAD AMPERES	SPR SW	SPLIT WIRE RECEPTACLE SWITCH
FVNR	FULL VOLTAGE, NON-REVERSING	SWBD	SWITCH BOARD
FVR	FULL VOLTAGE, REVERSING	TC	TEMPERATURE CONTROL
GC	GENERAL CONTRACTOR	TC	TELEPHONE CABINET
FD FEN	GARBAGE DISPOSAL GENERATOR	TCC TEL	TEMPERATURE CONTROL CONTRACTOR TELEPHONE
FI or GFCI	GROUND FAULT CIRCUIT INTERRUPTER	TL	TWIST LOCK
RC ND or GRND	GALVANIZED RIGID CONDUIT GROUND	TR, TRANS or TRFMR	TRANSFORMER TELEPHONE TERMINATION BOARD
		TV	TELEVISION
I & AC I & V	HEATING & AIR CONDITIONING HEATING & VENTILATING	TVSS TYP	TRANSIENT VOLTAGE SURGE SUPPRESSION TYPICAL
AI	HANDICAP ACCESS DOOR		
ID HID	HAND DRYER HIGH INTENSITY DISCHARGE	UH	UNDERGROUND UNIT HEATER
IP	HORSE POWER	UV	UNIT VENTILATOR
IPS ITG	HIGH PRESSURE SODIUM HEATING	v	VOLT
ITR	HEATER	VFD	VARIABLE FREQUENCY DRIVE
IVAC	HEATING, VENTILATION & AIR CONDITIONING	W	WATT OR WIRE
ΗZ	HERTZ (CYCLES/SEC)	W/	WITH
I.C	INTERRUPTING CURRENT	W/O WP	WITHOUT WEATHERPROOF
CGR	ISOLATED GROUND RECEPTACLE	WTR or H20	WATER
IMC	INTERMEDIATE METAL CONDUIT INCANDESCENT	WS	WINDOW SHADE
ISO	ISOLATED OR ISOLATION	XFMR	TRANSFORMER
J, JB or J-BOX	JUNCTION BOX	Υ	WYE CONNECTION
CCMIL CV	THOUSAND CIRCULAR MILS KILOVOLT	\U+0278	PHASE
CVA	KILOVOLT - AMPERE	\U+0394	DELTA
CVAR	KILOVOLT - AMPERE REACTIVE KILOWATT		
CWH	KILOWATT - HOUR		

				MERA T				,	VTING		OF I	IONS	
CAMERA DESIGNATION	SHOWN ON DWG	360 PANORAMIC	180 PANORAMIC	PTZ	FISHEYE	FIXED	WALL	RECESSED CEILING	SURFACE CEILING	PENDENT	HEATER/ BLOWER	DAY/ NIGHT	
LETTER	SHEET#	PANC	PANC		FIS	E	>	RECI	SUR	PEN	HE,	DAY/	REMARKS
C1 C2	E3.00	Х	Х				Х	Х			Х	Х	NOTES: 4 NOTES: 2
C3 C4	E3.00	Х	Х				Х	Х			Х	X	NOTES: 2 NOTES: 4
C5	E3.00	X	^				, , , , , , , , , , , , , , , , , , ,	Х		V		X	NOTES: 2
C6 C7	E3.00	Х	Х					Х		X			NOTES: 2 NOTES: 2
C8 C9	E3.00		Х			Х		X					NOTES: 2 NOTES: 2, 3
C10 C11	E3.00	Х				Х		X					NOTES: 2 NOTES: 2
C12 C13	E3.00	X						Х					NOTES: 2 NOTES: 2
C14	E4.00	^				Х		X					NOTES: 2, 3
C15 C16	E4.00		Х			Х		X					NOTES: 2, 3 NOTES: 2
C17 C18	E4.00		Х			X		X					NOTES: 2 NOTES: 2
C19 C20	E4.00 E4.00	Х	Х				Х	Х			Х	Х	NOTES: 4 NOTES: 2
C21	E3.00 E4.00	~	X							Х			NOTES: 1
C22 C23	E4.00	Х	Х					X					NOTES: 2 NOTES: 2
C24 C25	E5.00 E5.00		Х			Х		Х	Х				NOTES: 1 NOTES: 2, 3
C26 C27	E5.00 E5.00	Х				Х		X					NOTES: 2, 3 NOTES: 2
C28	E5.00	Х						Х					NOTES: 2
C29 C30	E5.00	X						X					NOTES: 2 NOTES: 2
C31 C32	E5.00 E5.00	Х		<u> </u>		Х		X					NOTES: 2, 3 NOTES: 2
C33	E5.00 E5.00	Х	Х				X				Х		NOTES: 4
C35	E5.00	Х						\ \ \ \ \ \ \ \ \ \ \ \ \ \ \ \ \ \ \	Х				NOTES: 1
C36 C37	E5.00		X					X					NOTES: 2 NOTES: 2
C38 C39	E6.00 E6.00		Х			Х			X	Х			NOTES: 1 NOTES: 5
C40 C41	E6.00 E6.00	Х	Х				Х		Х				NOTES: 1
C42 C43	E6.00		X X				X				X	 	NOTES: 4 NOTES: 4
C44	E7.00		X							Х			NOTES: 1
C45 C46	E7.00 E7.00	X					X	Х			Х	Х	NOTES: 4 NOTES: 2
C47 C48	E7.00 E7.00	X					Х	X			Х	Х	NOTES: 4 NOTES: 2
C49 C50	E7.00 E7.00		Х			Х		Х		Х			NOTES: 1 NOTES: 2
C51	E7.00		.,			X	.,	X			.,		NOTES: 2
C52 C53	E7.00 E7.00	Х	Х				Х	Х			Х	X	NOTES: 4 NOTES: 2
C54 C55	E7.00 E7.00		X				Х	Х			Х	Х	NOTES: 2 NOTES: 4
C56 C57	E7.00 E8.00		Х			Х			X				NOTES: 1 NOTES: 6
C58	E8.00					Х			Х				NOTES: 6
C59 C60	E8.00					X			X				NOTES: 6 NOTES: 6
C61 C62	E8.00	Х				Х		X					NOTES: 2 NOTES: 2
C63	E8.00			Х		X	Х	X			Х		NOTES: 4 NOTES: 2
C65 C66	E8.00	Х		Х			Х	Х			Х		NOTES: 2 NOTES: 4
C67	E8.00		.,	X			X	,,			X		NOTES: 4
C68 C69	E8.00		X					X					NOTES: 2 NOTES: 2
C70 C71	E8.00	Х		Х			Х	Х			Х	Х	NOTES: 4 NOTES: 2
C72 C73	E9.00 E9.00		X X							X			NOTES: 2 NOTES: 2
C74	E9.00		Х					X		^			NOTES: 2
C75 C76	E9.00		X					X					NOTES: 2 NOTES: 2
C77 C78	E9.00 E9.00	Х	Х					X					NOTES: 2 NOTES: 2
C79 C80	E9.00 E9.00		X					X					NOTES: 2 NOTES: 2
C81 C82	E10.00	Х	X					X	Х				NOTES: 1 NOTES: 2
C83	E10.00	^	X					Х					NOTES: 2
C84 C85	E10.00	Х	Х					Х		Х			NOTES: 2 NOTES: 2
C86 C87	E10.00		X				X				Х	X	NOTES: 4
C88	E8.00 E4.00		Х			Х	Х	Х			Х		NOTES: 2, 3 NOTES: 4
C90	E11.00		Х				Х				Х	Х	NOTES: 4, 7
C91 C92	E11.00		X				X				X	1	NOTES: 4, 7 NOTES: 4, 7
C93 C94	E11.00				X				X				NOTES: 8
C95	E11.00 E11.00				X				X				NOTES: 8 NOTES: 8
C97	E11.00				Х				Х				NOTES: 8
C98 C99	E11.00				X				X				NOTES: 8
C100 C101	E11.00		Х		X		X				Х	X	NOTES: 4
C102 C103	E11.00		X				X				X		NOTES: 4, 7 NOTES: 4, 7
C104	E11.00		^		X			X			^		NOTES: 2
C105 C106	E11.00				X			Х	Х				NOTES: 2 NOTES: 8
C107 C108	E11.00 E11.00					X	X				X X		NOTES: 4, 7 NOTES: 4, 7
C109 C110	E11.00 E11.00				X		X						NOTES: 9
C110	E7.00	 		Х	_^		<u> </u>						NOTES: 10

CCTV CAMERA SCHEDULE

2. CAMERA IS BEING MOUNTED IN LAY-IN CEILING. CONTRACTOR TO PROVIDE INDEPENDENT SUPPORT FOR CAMERA FROM STRUCTURE.

3. CAMERA IS BEING MOUNTED OVER COUNTER. CAMERA TO VIEW ACTIVITY ON COUNTER. 4. PROVIDE 120V CONNECTION AND 12V DC TRANSFORMER FOR HEATER/BLOWER.

5. CAMERA IS BEING MOUNTED ON HARD CEILING IN AN UNFINISHED SPACE. CONTRACTOR MAY SURFACE MOUNT CONDUIT TO CAMERA. 6. CAMERA IS BEING MOUNTED ON HARD CEILING IN CORNER IN AN ISOLATION ROOM. CONTRACTOR TO PROVIDE VANDAL RESISTANT ENCLOSURE

WITH INFRARED (IR) LIGHTING FOR COVERAGE OF ROOM SERVED. 7. CAMERA IS BEING MOUNTED ON EXTERIOR ROCK WALL. CONTRACTOR WILL NEED TO PROVIDE PLYWOOD BACKING TO PROVIDE A SURFACE

BEHIND CAMERA ENCLOSURE TO ENSURE WEATHER TIGHT SEAL.

8. CAMERA IS BEING MOUNTED ON HARD CEILING. CONTRACTOR TO ROUTE ALL CABLING TO CAMERA THROUGH ATTIC SPACE. 9. CAMERA IS BEING MOUNTED ON WALL. CONTRACTOR TO ROUTE ALL CABLING TO CAMERA THROUGH ATTIC SPACE AND THEN INSIDE

WALL DOWN TO CAMERA LOCATION. 10. POST MOUNTED CAMERA ABOVE BUILDING 145 PENTHOUSE ROOF.

		CONSULTANTS:		ARCHITECT/	ENGINEERS:	Drawing Title ELECTRICAL	Project Title CCTV Secur	ty Camera System	Project Number 568-12-103	Office of
		WPE #BR11046	PROFESS/ONAL PROFE		517 Seventh Street Rapid City, SD 57701	SYMBOLS/ABBREVIATIONS/SCHEDULES/RISE	REBID -		Building Number 113, 145, 146,	Construction 148 and Facilities
		WEST PLAINS ENGINEERING, INC. 1750 RAND ROAD = RAPID CITY, SD 57702 PHONE: (605) 348-7455 = FAX: (605) 348-9445	7595 MICRAEL RAYMOND SIGMAN	FOURFRONT	(605) 342-9470	Approved: Project Director	Location Ft. Meade, South Dakota		Drawing Number	Management
Revisions:	Date	www.westplainsengineering.com RAPID CITY, SD ■ SIOUX FALLS, SD ■ CASPER, WY ■ CEDAR RAPIDS, IA	THE WAY DAY OF THE PARTY OF THE	DESIGN INC.	10.1749.008		Date 11/16/12	Checked Drawn MRS VLS		

VA FORM 08-6231